

Office Use Only Application Number:

Application for Temporary or Marginal Activity

Pursuant to Section 87BB of the Resource Management Act 1991 (the Act)

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To qualify to be a marginal or temporary activity, a proposed activity must meet the following criteria:

- The activity would be a permitted activity except for a marginal or temporary non-compliance with requirements, conditions, and permissions specified in this Act, regulations (including any national environmental standard), a plan, or a proposed plan; and
- Any adverse environmental effects of the activity are no different in character, intensity, or scale than they would be in the absence of the marginal or temporary non-compliance referred to above; and
- Any adverse effects of the activity on a person are less than minor.

Prior to, and during, completion of this application form, please refer to Resource Consent Guidance Notes and Schedule of Fees and Charges – both available on the Council's web page.

1. Pre-Lodgement M	leeting
Have you met with a Council	Resource Consent representative to discuss this application prior to lodgement? Yes No
2. Applicant Details:	
Name	Olaf Guy Eady and Simon Holm Eady and Joanna Maitland Chaplin
Email (Electronic address for service)	
Postal address (or alternative method of service under section 352 of the Act)	
3. Address for Corre	
	correspondence (if using an Agent write their details here).
Name Email (Electronic address for service)	Graeme Cunningham
Postal address (or alternative method of service under section 352 of the Act)	

All correspondence will be sent by email in the first instance.

Please advise us if you would prefer an alternative means of communication.

4. Details of Property Owner/s and Occupier/s:				
(Name and Address of the Owner/Occupiers of the land to which this application relates (where there are multiple owners or occupiers please list on a separate sheet if required)				
Name / s	As per applicant			
Property address / location				
			Postcode	
5. Application Site	Details:			
Location and/or Property	Street Address of the proposed activit	y:		
Site address/location	178C Rawhiti Road, Russell			
			2 1 0070	
			Postcode 0272	
Legal description	Lot 2 Deposited Plan 122586	Val number		
Certificate of title	NA71B/440			
	attach a copy of your Certificate of Title or easements and encumbrances (searc		_	
6. Description of the	he Temporary or Marginal	Activity:		
	roposal in sufficient detail to justify wl n and assessment of any District Plan		is a 'marginal' or temporary' activity. oposed activity does not comply with:	
	d with landscape trees in very close proximity. The		inor, being only 300mm past the existing building line	
and therefore any change in the relationship of the building to any surrounding trees is less than minor. The activity would be permitted activity except for marginal non compliance. Any adverse environmental effects of the activity are no different in character, intensity, or scale than they would be in the absence of the marginal or temporary non-compliance referred to above; Therefore the activity can be considered marginal and not in conflict with the current district plan.				
Rule: 10.6.5.1.2 RESIDENTIAL INTENSITY A second laundry and kitchenette is proposed to the existing dwelling. This is an overflow space for holiday guests and or the kids and their friends.				
The owners will not be using the space as a second tenancy as suggested. Evidence of this is no tenancy fire/acoustic separation upgrades are proposed via BC to create a second legal sleeping cell. The activity would be a permitted activity except for a marginal or temporary non-compliance with requirements,				
there are no adverse environmental effects and no adverse effects of the activity. Therefore the activity can be considered marginal and not in conflict with the current district plan.				
7. Other Consent required/being applied for under different legislation:				
(more than one circle can be ticked)				
Building Consent (BC ref # if known) BC EBC-2025-168/0				
Other (please specify)				

9. Billing Details:

This identifies the person or entity that will be responsible for paying any invoices or receiving any refunds associated with processing this resource consent. Please also refer to Council's Fees and Charges Schedule.

Postal address
(or alternative method of service under section 352 of the Act)

Work phone

Email (Electronic address for service)

Fees Information

An instalment fee for processing this application is payable at the time of lodgement and must accompany your application in order for it to be lodged. Please note that if the instalment fee is insufficient to cover the actual and reasonable costs of work undertaken to process the application you will be required to pay any additional costs. Invoiced amounts are payable by the 20th of the month following invoice date. You may also be required to make additional payments if your application requires notification.

Declaration concerning Payment of Fees

I/we understand that the Council may charge me/us for all costs actually and reasonably incurred in processing this application. Subject to my/our rights under Sections 357B and 358 of the RMA, to object to any costs, I/we undertake to pay all and future processing costs incurred by the Council. Without limiting the Far North District Council's legal rights if any steps (including the use of debt collection agencies) are necessary to recover unpaid processing costs I/we agree to pay all costs of recovering those processing costs. If this application is made on behalf of a trust (private or family), a society (incorporated or unincorporated) or a company in signing this application I/we are binding the trust, society or company to pay all the above costs and guaranteeing to pay all the above costs in my/our personal capacity.

Name of bill payer (please print)			
Signature of bill payer (mandatory)		Date	11/11/2025
	Guy Eady		

Checklist

CIII	ECKIISC
0	Payment
0	Payment (cheques payable to Far North District Council)
0	A current Certificate of Title (Search Copy not more than 6 months old)
0	Copies of any listed encumbrances, easements and/or consent notices relevant to the application
0	Applicant / Agent / Property Owner / Bill Payer details provided
0	Location of property and description of proposal
0	Written approvals and a signed plan from each owner of an allotment with an infringed boundary
0	Copies of other relevant consents associated with this application
0	Location and Site plans
0	Elevations / Floor plans
0	Topographical / contour plans

Note to applicant

You must include all information required by this form. If all information is not included, the consent authority will return this to you and the correct information must be supplied before a written notice permitting your activity can be provided.



RECORD OF TITLE UNDER LAND TRANSFER ACT 2017 FREEHOLD

Search Copy



Identifier NA71B/440

Land Registration District North Auckland

Date Issued 30 May 1988

Prior References NA46C/166


Estate Fee Simple

Area 5605 square metres more or less Legal Description Lot 2 Deposited Plan 122586

Registered Owners

Joanna Maitland Chaplin, Olaf Guy Eady and Simon Holm Eady

Interests

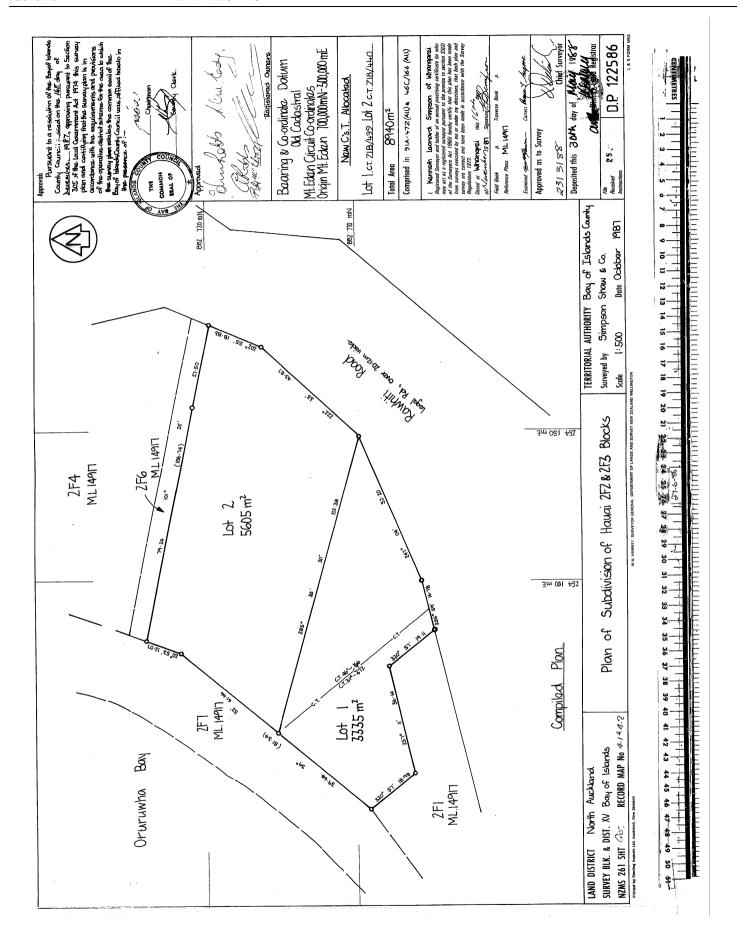

A0	Site	
	A001	Cover Page
	A002	Proposed Site Plan
A1	Plans	
	A101	Existing Ground Floor Plan
	A102	Existing First Floor Plan
	A103	Proposed Ground Floor Plan
	A104	Proposed First Floor Plan
	A105	First Floor Framing and Bracing Plan
	A106	Foundation Plan
	A107	Framing Plans
75.	A108	Roof Plans
9 2	levations	
Ŀ	A201	Elevation
7	A202	Elevation
0 3	ections	On attenda
11	A301 A302	Section A Section CC
5	A3UZ	
1	roject Specific Def	
<u>. </u>	A401 A402	Sliding door Jamb details Sliding door Head & Sill details
2	A402 A403	Details
ō	A404	Window Details
_	A405	Window Details Window Details
ğ	A406	Blockwall cladding details
A 5	tandard Details	Blockwan diadding details
وّ	A501	Foundation Details
86	A502	LUMBERLOK Joist Stiffener & Top Plate Fixing
-16	A503	LUMBERLOK Lintel Fixing Schedule
5	A504	LUMBERLOK Purlin & Batten Fixing Detail
men≰ - EBC-2025-168/0 _万 Pg 1 of 31 - ≨/11/2624	A505	
7	A303	Roof Bracing & Durability for Steel Fixing/Fastenings
ဗ္ဗ	A506	Framing Fixing Detail
ш	A507	Wet Area Detail
<u> </u>	A508	Mitek fixings
70	Vindow/Door Sche	
ĭ	A601 A602	Window / Door Schedule Window / Door Schedule
 ק	A602 A603	Window/ Door Schedule Window/ Door Schedule
8	A003	Williadw/ Bool Schedule
ŠΙΤ	INFORMATION	
	DRESS: 178 RAWHIT BAL DESCRIPTION: I	T ROAD, RAWHITI 0184
(a)	E AREA: 5623m²	2012 51 122500
ŒEA	RTHQUAKE ZONE : Z	
	POSURE ZONE: ZON ID ZONE: HIGH	ED
5		
A R	HITECTURAL A	BBREVIATIONS
O _C	ECK check dimensi	on & architectural break
CL	-	
MC(avel
OFF OFF	front of house	5761
₹FII	OP finished opening	
2 (H		penching for electrical
Q O/		nsions - clear from timber framing
⊄ S⊺	ROP structural oper	ning dimension
',™	to be confirme	d by contractor with BF
X EN	ERAL NOTES:	
Z۱		d in conjunction with all consultants drawings.
Ц	Notify architect of a	er framing to comply with NZS3604 - MSG8 or as

the fall height exceeds 1.0m AND where the upstairs WC or any other fixed features are located within 500mm horizontal of an opening window.

ARCHITECTURAL LEGEND

EXISTING

exta, timber framed walls

extg. timber framed walls removed

extg. timber framed walls upgraded

extg. 250mm concrete block wall extg. 200mm concrete block wall

WALL 1

90x45mm timber framed wall w. studs at 400mm crs nog vertically @ 800mm crs EXTERIOR: install PINK BATTS CLASSIC

R2.2 insulating wall pads to all external walls. Selected cladding to exterior also refer to elevations for cladding. INTERIOR: 10mm gib for stopped & L4 paint finish interior.

BATHROOM: 10mm GIB AQUALINE

PROPOSED JOINERY

ALUMINIUM JOINERY

new SELECTED aluminium window DGU all clear glass.

Obscure glass for bathrooms. Refer to window schedule

INTERIOR: DOOR JOINERY

new 40mm hollow core panel door for paint finish w. selected hardware. Groved jamb

GENERAL

terminal vent

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HPM INLINE ceiling Exhaust fan for min 50L/s exhaust 100mm duct. Refer to elevations for location of gravity grille.

check on site

oa

ELECTRICAL



Domestic Smoke Alarm*

standards:UL217, ULC S531, AS3786, BS5446:Part1, are to be installed on or near the ceiling in accordance with Australian Standard AS1670.6. Alarms must have a hush facility located on the alarm itself. Owner is responsible for maintenance of the system as per manufacturer's recommendations



hotwater cylinder

Install 100mm proprietary restrictors for all window sill openings within 760mm from the inside floor level where

ELEMENTAL LEGEND

All fixings in accordance with NZS3604.2011unless noted otherwise

STRUCTURE: all new timber structure SG8

- S 20) new timber lintel-w/ min. uplift-fixing as per A4.05 LUMBERLOC fixing schedule
- S 21 new timber stringer 140x45 H3.2 fixed with M12 bolt @1200crs
- (\$ 30) new 90x45 wall studs @ 400 ctrs nog @ 800mm crs, top & bottom plates, fixed as per NZS 3604
- S 31) selected flooring material CHH ECOPLY 18mm flooring
- (\$ 32) new rafters framing at 900 crs subject to site measure install
- (\$33) new 70x45mm timber purlin T fixing 1/10gm self drilling screw 80mm long (alternative 2.4kN fixing permitted)
- S 34) LUMBERLOK 0.55x27mm G550 Z275 roof strip brace
- S 40) selected 18mm timber decking fixed with SPAX screws TBC
- (\$ 42) balustrade TBC
- § 50) 125x125mm H5 senton pile ordinary & braced 600mm deep minimum anchor 900mm deep minimum

- (E 01) THERMAKRAFT dpc
- E 02 SIKA BLACK SEAL ELASTIC brush applied waterproofing coating
- E 03) THERMAKRAFT supercourse 500

(S 41) timber deck joist or deck batten

- **E 10** Roof THERMAKRAFT COVERTEK 407 to lap
- (E 11) Walls THERMAKRAFT WATER GATE PLUS to lap
- E 12 THERMAKRAFT ALUBAND flashing tape
- (E 13) 10mm H3.2 treated timber packer and airseal.
- (E 14) nylon packer
- (E 15) 6mm JH VILLABOARD LINING soffit plastered smooth
- E 16) 20x20mm timber scriber w/ silicone seal
- E 18) 60x10mm to match extg architrave
- (E 19) battens H3.2 90x20mm over exterior grade jack framing 20mm gap
- E 20 H3.2 to match extg RP bevelback weatherboard circa 135x18mmm for paint finish direct fix with galvanised 60x2.8mm nails. Refer paint finishes schedule &
- (E 24) HUME PINE PINECLAD H3.1 Square Dressed Board 90x18mm
- E 25) HUME PINE PINECLAD H3.1 Square Dressed Board 180x18mm DS4 cut suit
- E 26 HUME PINE PRO SCRIBER 18mm H3.1 w/ silicone seal (E 27) HUME PINE PINECLAD H3.1 timber fascia. Color to match - TBC
- (E 28) REDWAYEXTRUSIONS uPVC 20mm cavity closer
- (E 29) REDWAYEXTRUSIONS uPVC flashing. Refer product for selection.
- $\hbox{$\stackrel{\frown}{\hbox{$\rm E$}$ 30}$} \ \ ROOFING\ INDUSTRIES\ CORRUGATE\ \ profile\ 0.55mm\ \ BMT\ \ COLORSTEEL.$
- 0.4mm BMT COLOUR STEEL flashing to match purpose made. Match roofing
- (E 32) QUICKFLASH aluminium flashing. Refer QUICKFLASH product code for selection
- (E 33) ROOFING INDUSTRIES QUARTER ROUND GUTTER with COLOURSTEEL dp. Match roofing refer Colour Schedule. (E 34) VIKING TPO ENVIROCLAD membrane over 17.5 mm plywood SS screw fixing
- © 35) DEKTITE PREMIUM flashing boot installed according to manufactures instructions allow for the correct size
- (E40) APL ALUMINIUM JOINERY w. DGU Awning, sliding and fixed windows, double track & entrance doors refer drawings. Confirm and allow for floor finishes including depth of carpet when constructing set down. Refer to colour schedule
- (E 42) timber window joinery

substrate on timber framing

- (E 50) PROPRIETARY window head flashing by window supplier
- E 51) RASOGUM+ liquid-applied waterproofing membrane
- E 52 Bowmac SS175 each side bracket connection bearer to conc block wall
- E 53) SS joist hang joists to stringer

for 90mm timber framing

- (i 01) R2.2 KNAUF wall insulation 90mm thk.
- (i 02) R3.6 KNAUF ceiling insulation 175mm thk. insulation post install.
- R1.5 KNAUF floor insulation 70mm thk.
- (i 04) 10mm thk polystyrene insulation strip (0.25m2 C/W)

FINISHES LEGEND WALL FINISHES TYPICAL NEW WALL new 10mm GIB board stopped level 4 paint finish direct fix to timber framing square stop at ceiling. Allow where required for packing to match existing gauge. Skirting LAUNDRYWALL & BATHROOM New 12mm T&G&V wall lining direct fix or on GIB selected client supplied tile over substrate CL1 NEW TYPICAL SOFFIT new JH VILLABOARD SOFFIT LINING stopped & level 4 paint finish CL2 NEW TYPICAL CEILING new 13mm GIB STANDARD or alternative stopped & level 4 paint finish on ceiling battens 65x35mm @ 600mm crs. FLOOR FINISHES FL1 new T&G solid wood flooring to match existing over polyurethane substrate FL2 Selected floor tile on 6mm james hardie backer board DL1 DECK 140mm timber decking w. SS fixings

DRAINAGE & PLUMBING LEGEND description SS drain pipe. Refer plan for size. subfloor riser. Refer to plan for size. 50 mm sleeve for 100DN 80DN down pipe minimum for SW. Refer plan for downpipe 65DN minimum termnial vent to roof for branch drain. Boot flashing over roof penetration arrow slope down - indicates all fall to main drain connection Overflow relief gully. Sill cock to charge OFG. Inspection point laundry washing tub air admittance valve Tile Shower man hole Town water supply connection all pipes minimum grade falls in wall: 40DN 1:40 AS PER G13 OR AS/NZS 3500 all pipe support points to be: 50mm 500mm AS PER G13 OR AS/NZS 3500 Plumbing Contractor is to verify that all plumbing fixture level and pipe gradients meet minimum building code and plumbing standards before starting work. Hot water cylinder shall have operating devices, safety devices, a draine safe tray and seismic restraints in accordance with NZBC Hot water pipework shall be thermally insulated

GOODHOUSE

TIMBER TREATMENT & GRADE SPECIFICATION				
Member	Species	Grade	Treatmen	
FLOOR FRAMING - RA	ADIATA PINE			
	5 1:	550		
Mid floor joists: Boundary joists:	Radiata pine Radiata pine	SG8 SG8	H1.2 H1.2	
bouridary joists.	radiata pirie	300	111.2	
EXTERIOR WALL FRA	MING - RADIATA PI	NE		
Exterior walls:	Radiata pine	SG8	H1.2	
Parapets:	Radiata pine	SG8	H1.2	
Enclosed decks and balcor				
	Radiata pine	SG8	H1.2	
Cantilevered joists enclose	d decks and balconies:			
	Radiata pine	SG8	H3.2	
Wall battens (not cavity):				
	Radiata pine	Merch	H1.2	
Jamb battens:	Radiata Pine	Merch	H3.1	
CAVITY BATTENS				
CAVIII BAILENS				
Cavity battens Species Gra	de Treatment Timber -			
Non Structural:	Radiata pine	Merch	H3.1	
ROOF FRAMING - RAI	DIATA PINE			
Rafters:	Radiata pine	SG8	H1.2	
Trusses:	Radiata pine	SG8	H1.2	
Purlins:	Radiata pine	SG8	H1.2	
Ceiling joist & batten:	Radiata pine	SG8	H1.2	
Valley boards:	Radiata pine	Merch	H1.2	
Sarking:	Radiata pine	Merch	H1.2	
Skillion roof framing:	Radiata pine	SG8	H1.2	
Enclosed flat roof framing:	Radiata pine	SG8	H1.2	
INTERIOR FRAMING	RADIATA PINE			
Non structural walls:	Radiata pine	SG8	H1.2	
Structural and braced wall		SG8	H1.2	
	·		· · · · ·	
EXTERIOR EXPOSED	TIMBERS			
Posts:	Radiata pine	SG8	H3.2 CCA	
Joists:	Radiata pine	SG8	H3.2 CCA	
Exterior stairs and steps:		SG8	H3.2 CCA	
Pergola:	Radiata pine	SG8	H3.2 CCA	
Ground contact members	Radiata pine	SG8	H5 CCA	
Note all CCA to be presen	rativo codo 01 or 02			

Additions & Alterations for Eady Family at Oruruhoa Bay, Rawhiti Northland 0184

DIMENSIONS: Manufacturer to check dimensions, levels and trueness of walls on site. Where joinery unit is made to fit between walls or full height to underside of ceiling, generally allow for maximum 5mm clearance between joinery unit & wall/ceiling lining to ensure trouble free installation on site. Fill gap with approved black compressible strip to form negative detail.

NEW WORK: Timber framing to comply with NZS3604 - MSG8 or as

NEW WORK: Timber treatment to comply with NZS3602 - refer to

otherwise noted on drawings.

COMPONENT EXTERIOR WALLS

INTERIOR WALLS JOIST/RAFTERS - ENCLOSED

specification section 3801 carpentry.



31 - 6/11/2024 - vc

of 2

FNDC - Approved Building Consent Document - EBC-2025-168/0,-Pg



Site Image

Building Coverage N	et	m2		-
House (extg)		301.7		-
Addition		2.1		-
Total	5.40 %	303.8	COMPLIES	-
				-
Impermeable Cover	age <i>Gross</i>	m2_		-
Building Coverage		303.8		-
Driveway		663.4		-
Conc driveway area	to be removed	- 2.1	NO CHANGE	-
Total	17.16 %	965.1		-
Landscape area		m2		-
Landscape		4631.7		
Total	82.37 %	4631.7	COMPLIES	-
				-

LEGEND
New Extension
Existing building
New deck

Existing driveway

Project No. 24012 Date

28 AUG 24

Drawn By #Contact ID

Checked By

Drawing Title Proposed Site Plan


Building Consent

Drawing issue

Drawing

Drawing Number А002в

> 10/10/2024... BC RFI 17/09/2024... BC RFI

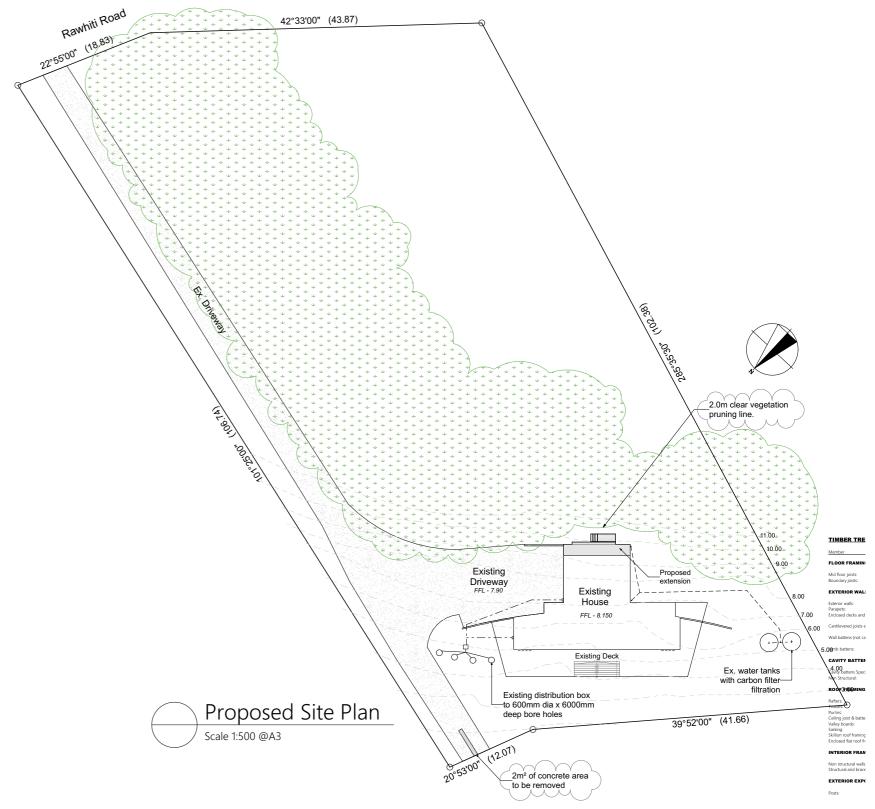


Eady Family

Additions & Alterations at Oruruhoa Bay, Rawhiti Northland 0184 GOODHOUSE NZ LTD 925 NEW NORTH ROAD, MOUNT ALBERT, **AUCKLAND 1025** (C) COPYRIGHT GOODHOUSE NZ LTD

D (09) 828 6699 | WWW.GOODHOUSE.NZ

ALL WORK TO COMPLY WITH NZBC 1992 & AMENDMENTS; ALL WORK TO COMPLY WITH NZS 3604 & RELEVANT STANDARDS WORKING DRAWINGS ARE INDICATIVE OF WORK TO BE DONE ONLY; DO NOT SCALE, USE FIGURED DIMENSIONS ONLY; CONTRACTOR TO VERIFY ALL DIMENSIONS BEFORE COMMENCING WORK ON SITE; DISCREPENCIES ARE TO BE VERIFIED WITH DESIGNER BEFORE COMMENCING WITH WORK; DRAWINGS TO BE READ IN CONJUNCTION WITH THE SPECIFICATION AND ENGINEERS DRAWINGS, ALL PROPRIETARY ITMES TO BE INSTALLED IN ACCORDANCE WITH MANUFACTURES SPECIFICATIONS.

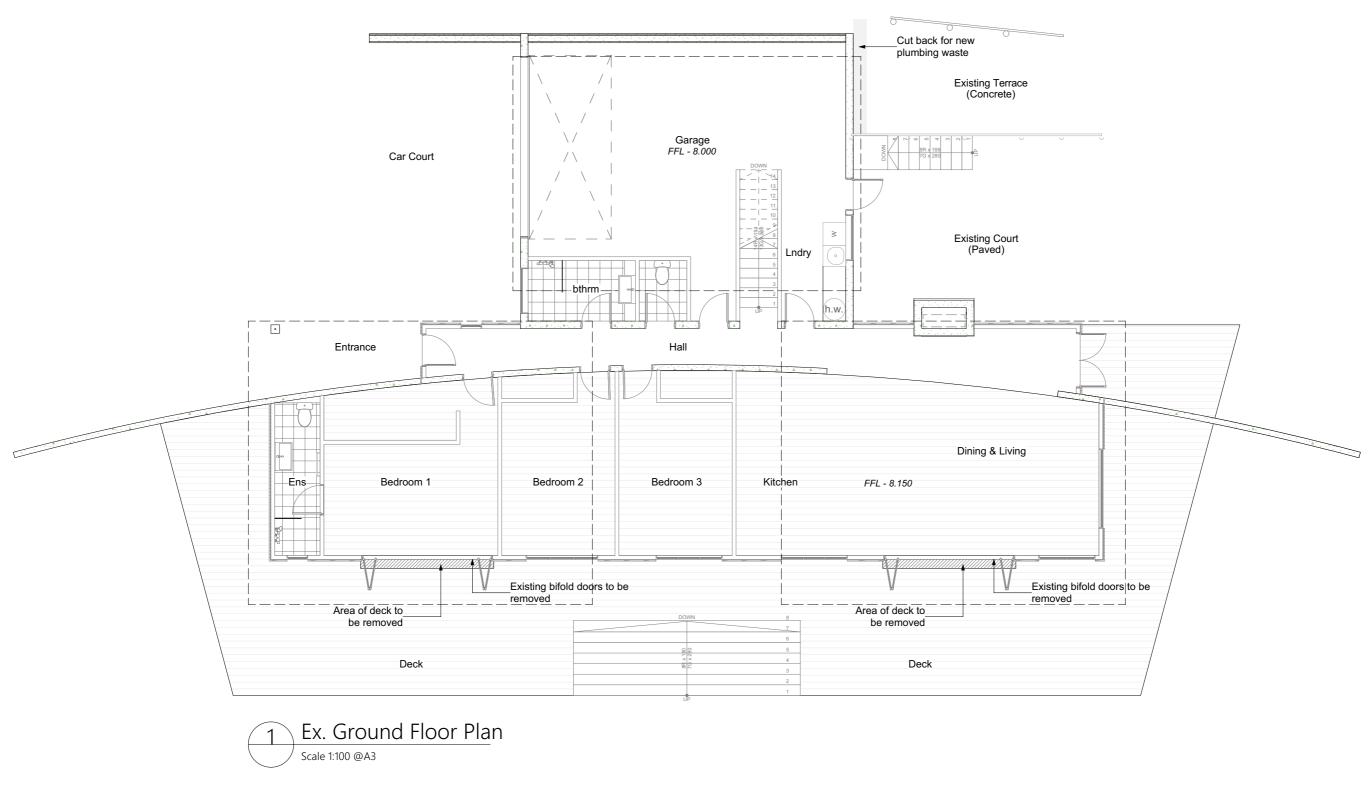

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Project No. Dr. 24012 #C

28 AUG 24

Drawing Title
#Contact ID Drawing Ground Floor Plan
Checked By Drawing issue


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Drawing Scale:

1:100

@A3

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Project No. 24012 Date

28 AUG 24

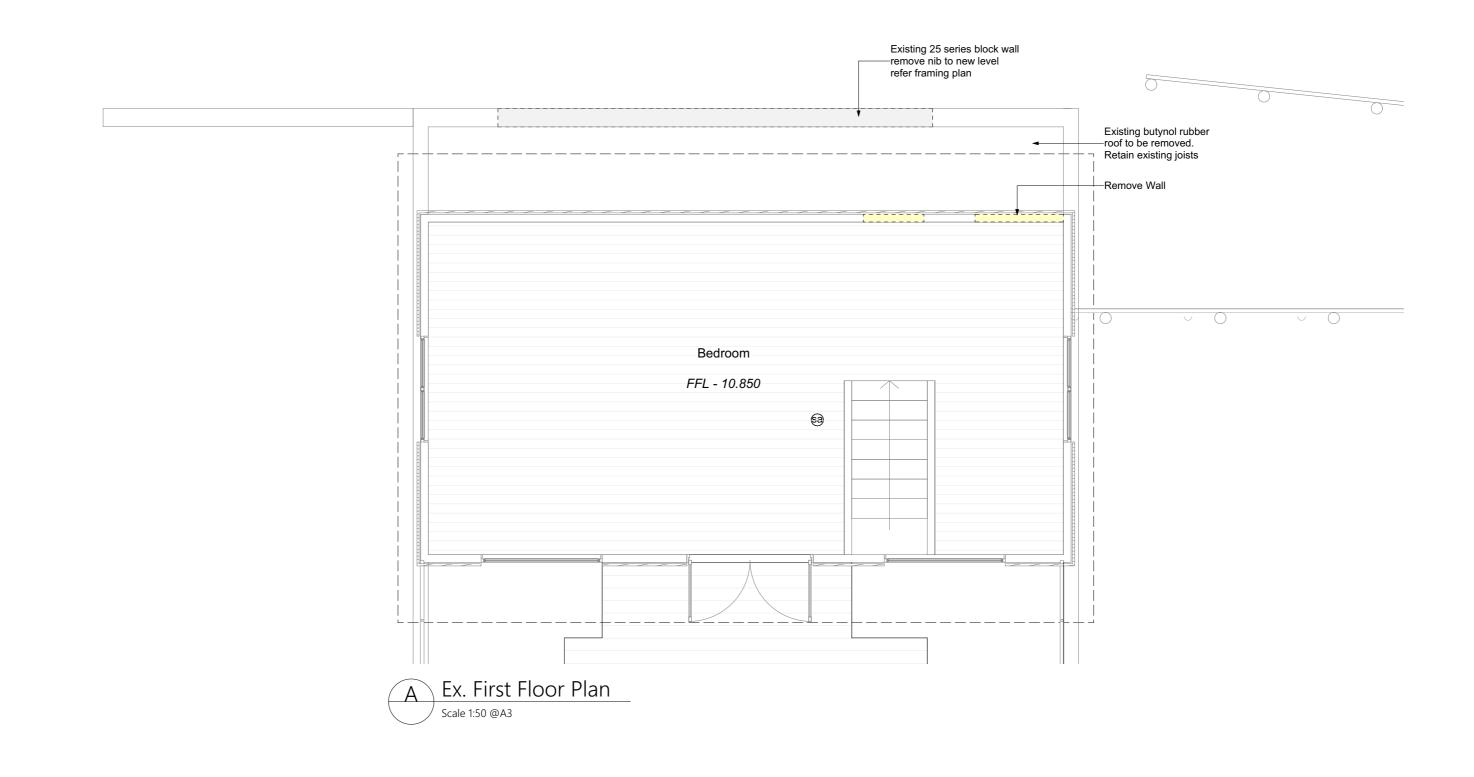Drawn By #Contact ID Checked By Drawing Title
Existing First Floor Plan
Drawing issue
Building Consent


Drawing Scale:

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Drawing Number
A102

Rev Date Title
D 4/11/2024 ... BC RFI



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Project No. 24012 Date

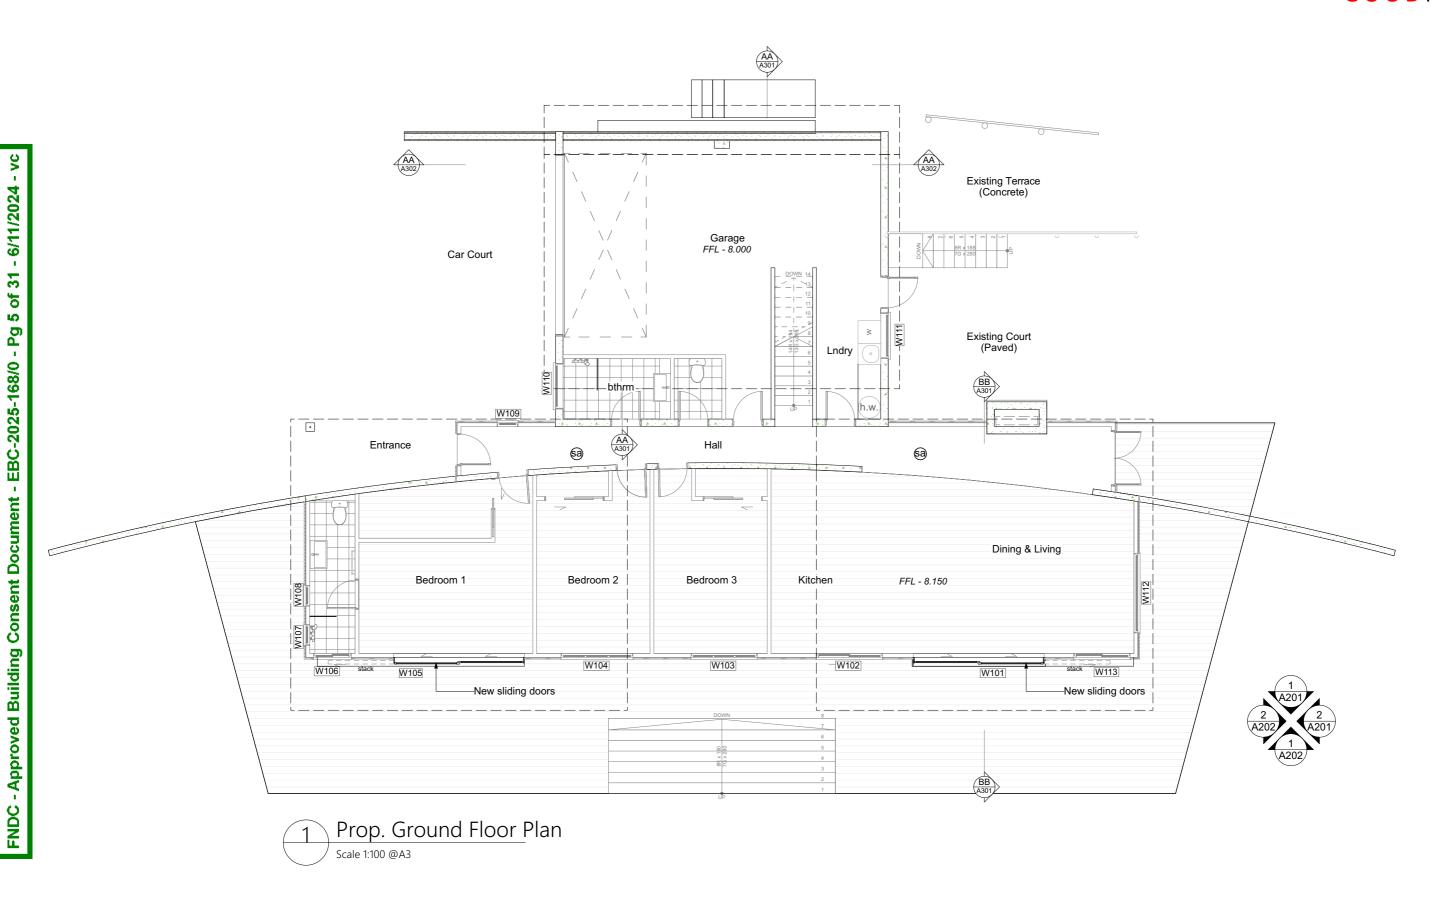28 AUG 24

Drawn By #Contact ID Checked By Drawing Title
Proposed Ground Floor Plan
Drawing issue


Building Consent

Drawing Scale:

1:100

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prawing Number A103

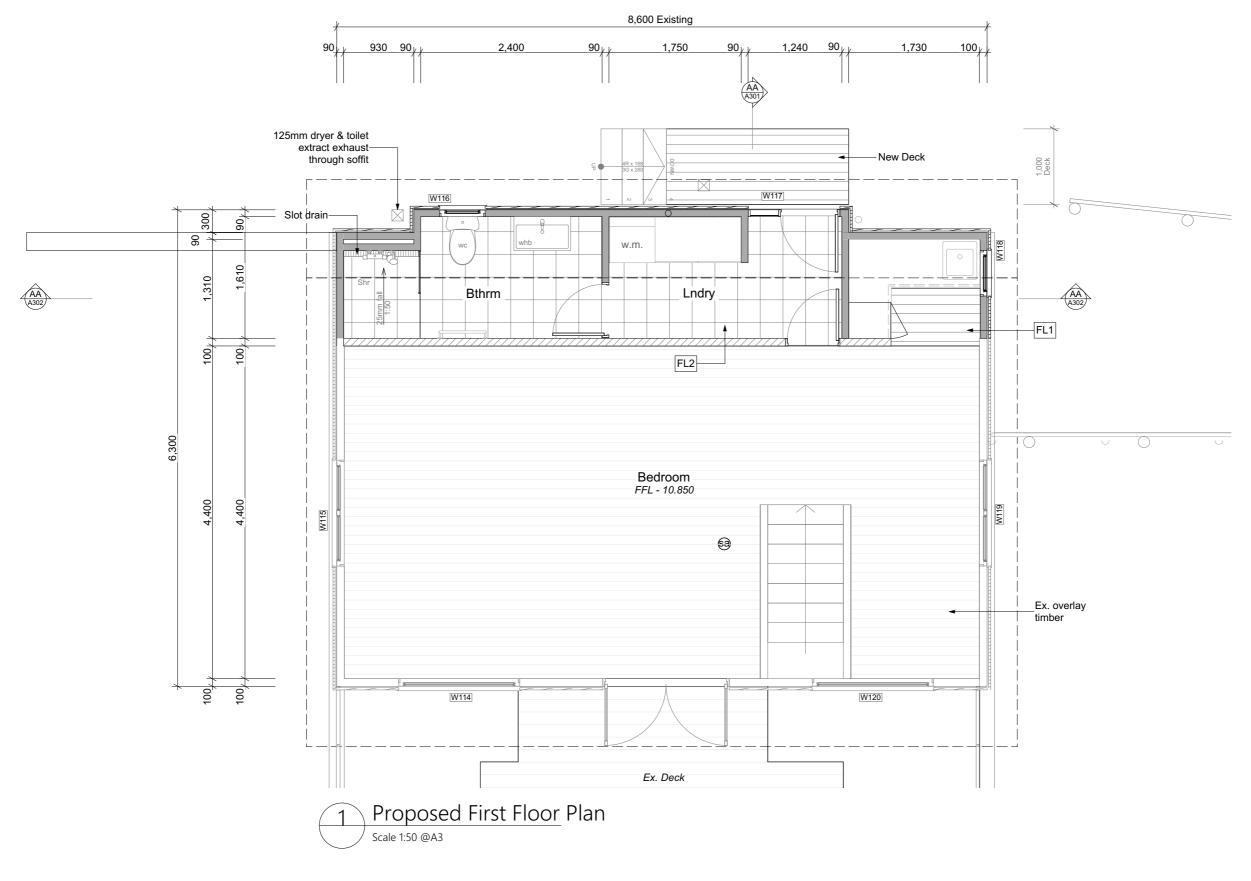

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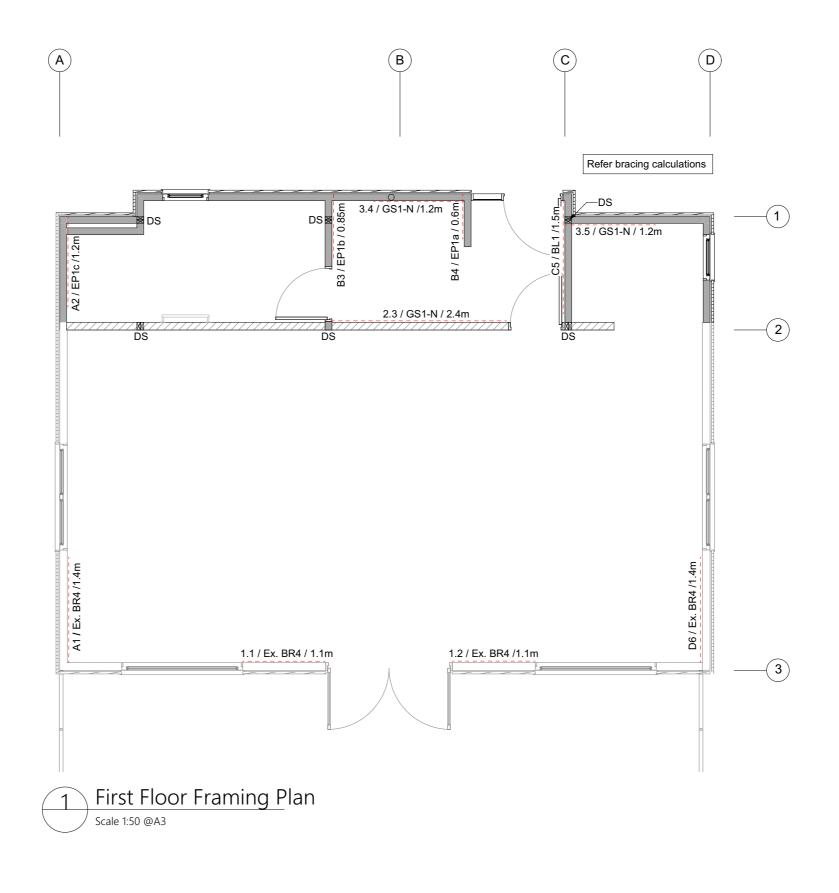
28 AUG 24

Drawn By #Contact ID Checked By Drawing Title Proposed First Floor Plan Drawing issue Building Consent Drawing Scale:

1:50

@A3

17/09/2024... BC RFI



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Project No. 24012

Date

28 AUG 24

Drawn By #Contact ID

Checked By

Drawing Title
First Floor Framing and
Bracing Plan
Drawing issue

Building Consent


Drawing Scale:

1:50

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10/10/2024... BC RFI

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Project No. 24012

Date

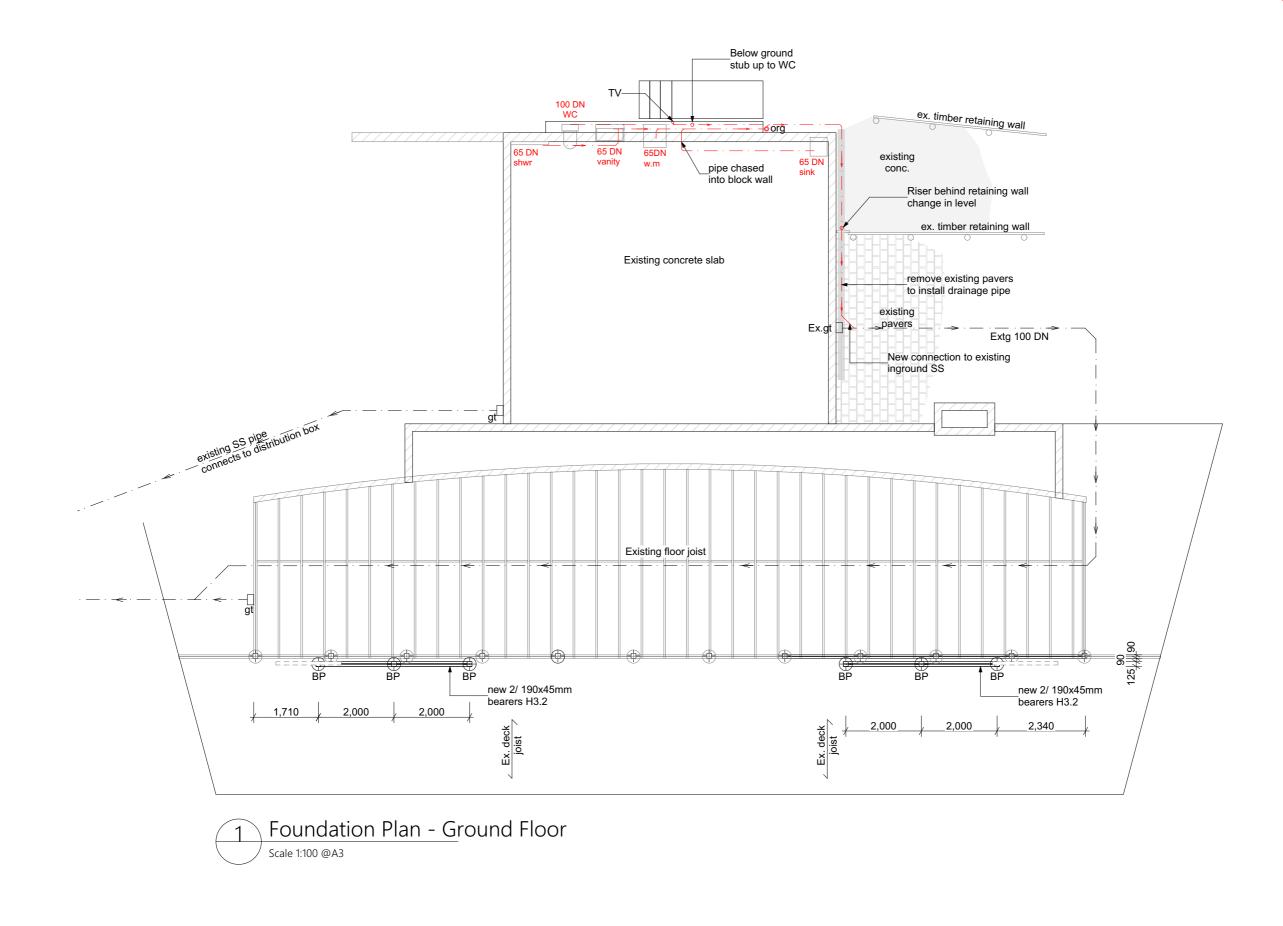28 AUG 24


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Drawing Number
A 106c

Rev	Date	Title
D	4/11/2024 ...	BC RFI
C	14/10/2024...	BC RFI



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Project No. 24012 Date

28 AUG 24
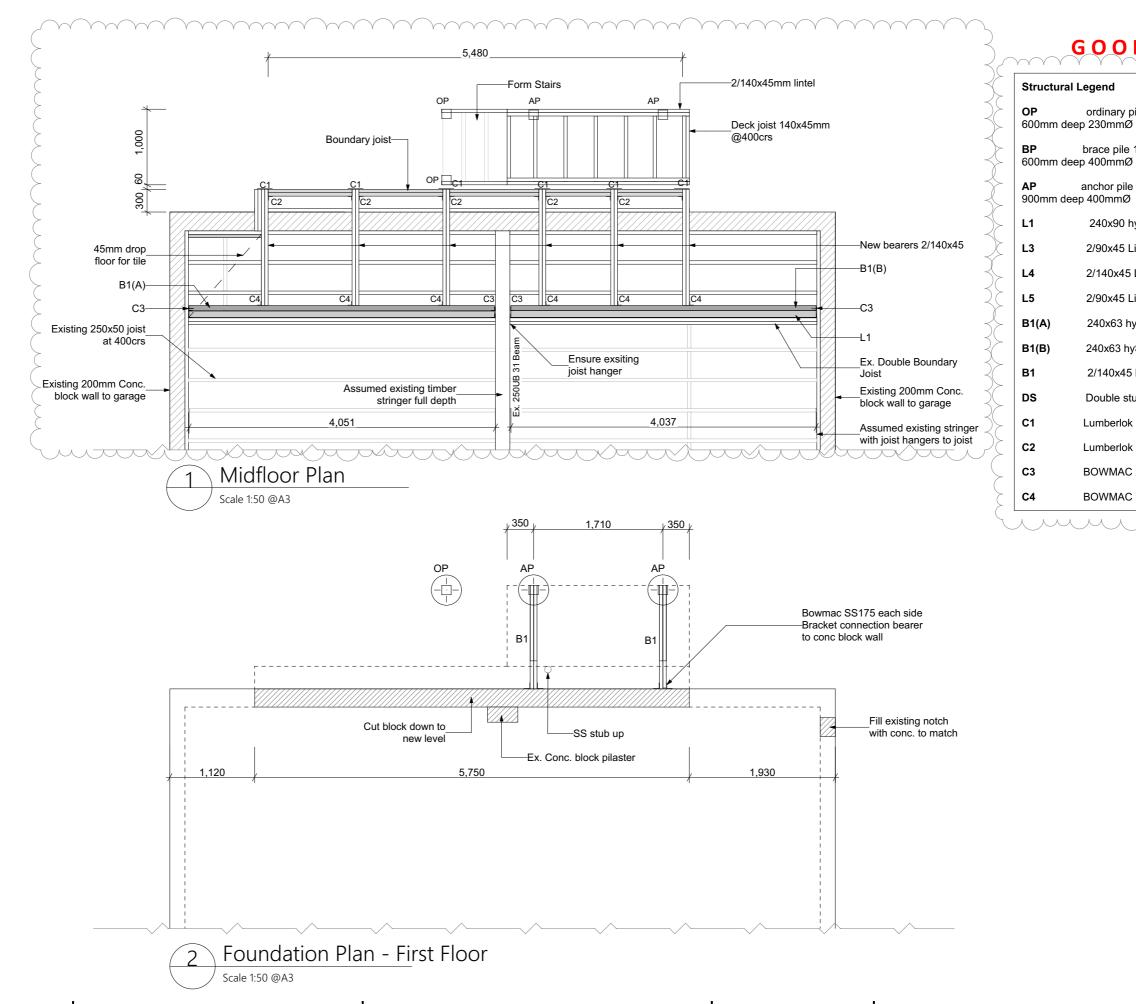
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Checked By **Building Consent**

Drawing Title Framing Plans Drawing issue

Drawing Scale:

1:50 @A3 **Drawing Number** A107_D

GOODHOUSE

ordinary pile 125mm sq senton pile

brace pile 125mm sq senton pile

anchor pile 125mm sq senton pile

2/90x45 Lintel SG8 Type E fixing

2/140x45 Lintel SG8 Type F fixing

2/90x45 Lintel SG8 Type E fixing

2/140x45 bearer SG8 H3.2

Lumberlok G300 2 x 113 x 320L

Lumberlok split hanger SPH 220

240x90 hyONE

240x63 hySPAN


240x63 hySPAN

Double stud

BOWMAC 2/B108


BOWMAC B117

ı			
ı	Rev	Date	Title
ı	D	4/11/2024	BC RFI
	С	14/10/2024	BC RFI
	В	10/10/2024	BC RFI
ı	Α	17/09/2024	BC RFI

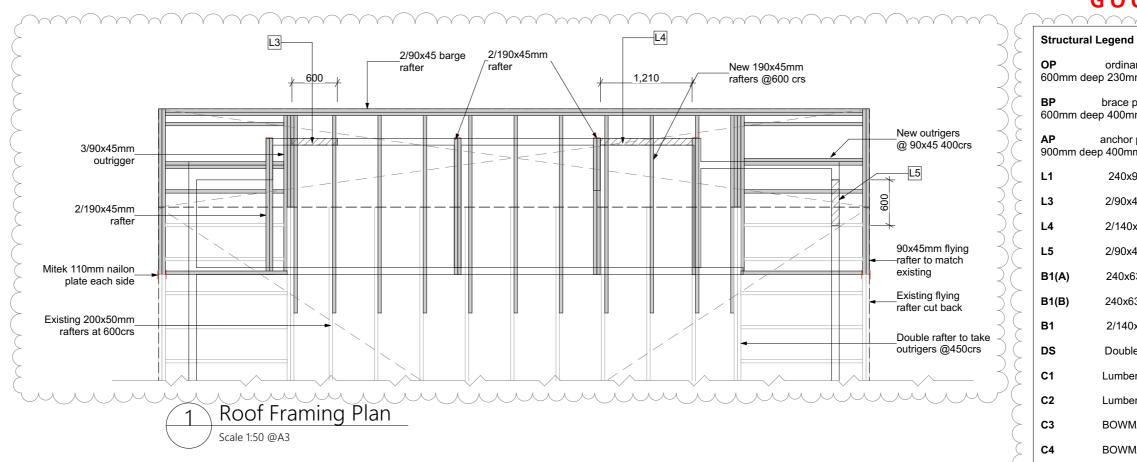

ordinary pile 125mm sq senton pile 600mm deep 230mmØ ВP brace pile 125mm sq senton pile 600mm deep 400mmØ AΡ anchor pile 125mm sq senton pile 900mm deep 400mmØ L1 240x90 hyONE L3 2/90x45 Lintel SG8 Type E fixing 2/140x45 Lintel SG8 Type F fixing L4 L5 2/90x45 Lintel SG8 Type E fixing B1(A) 240x63 hySPAN 240x63 hySPAN B1(B) **B1** 2/140x45 bearer SG8 H3.2 DS Double stud C1 Lumberlok G300 2 x 113 x 320L C2 Lumberlok split hanger SPH 220 C3 BOWMAC 2/B108 C4 **BOWMAC B117**

Existing roof area: 57.7m2 New roof area:

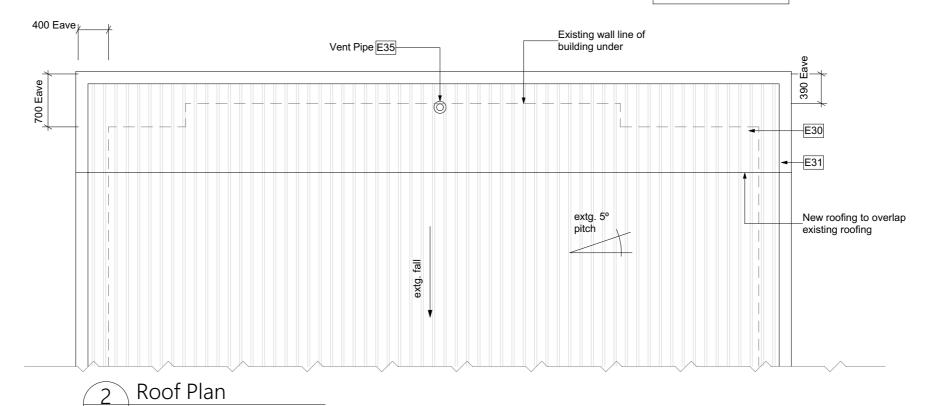

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Scale 1:50 @A3

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Project No. 24012 Date

28 AUG 24

Drawn By #Contact ID

Checked By

Drawing Title Roof Plans Drawing issue

Building Consent


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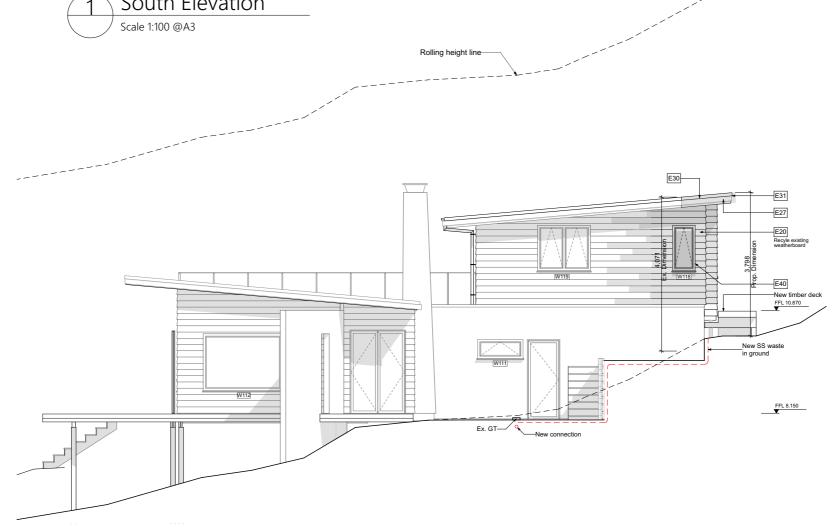
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Drawing Number A108_D

Rev Date Title 4/11/2024 ... BC RFI 14/10/2024... BC RFI 10/10/2024... BC RFI 17/09/2024... BC RFI





West Elevation Scale 1:100 @A3
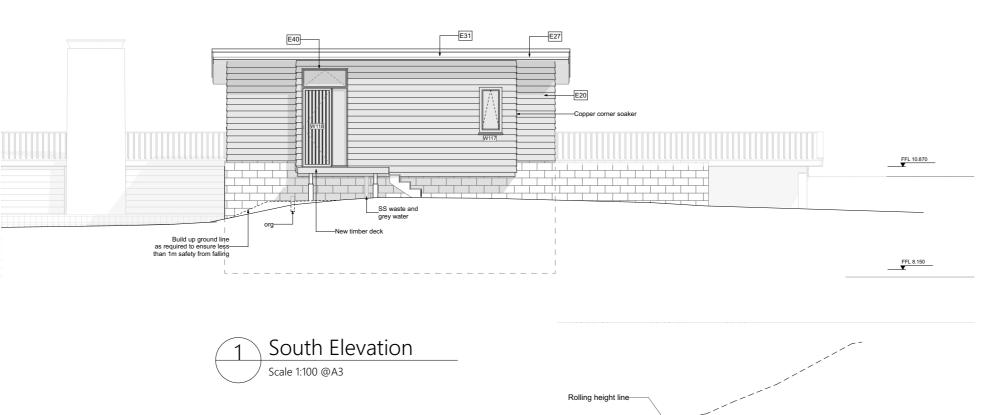
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Project No. Drawn By 24012 #Contact ID Date

28 AUG 24

Checked By **Building Consent**

Drawing Title Elevation Drawing issue Drawing Scale:

BUILDING ENVELOPE RISK MATRIX South Elevation

BUILDING ENVELOPE RISK MATRIX West Elevation

> Pev Date 4/11/2024 ... BC RFI 14/10/2024... BC RFI 10/10/2024... BC RFI 17/09/2024... BC RFI

Risk Severity Risk Score

Risk Severity Risk Score

0

0

High risk

Low risk

Medium risk

Low

High risk

High risk

Low risk

Medium risk

Low

High risk

Total Risk Score: Drawing Number A201_A

1:100

@A3

Risk Factor

Eaves width

Deck design Total Risk Score:

Risk Factor

Eaves width

Deck design

Wind zone (per NZS 3604)

Wind zone (per NZS 3604)

Roof/wall intersection design

Number of storeys


Envelope complexity

Roof/wall intersection design

Number of storeys

Envelope complexity

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North Elevation					
Risk Factor	Risk Severity	Risk Score			
Wind zone (per NZS 3604)	High risk	1			
Number of storeys	High risk	2			
Roof/wall intersection design	Low risk	0			
Eaves width	Medium risk	1			
Envelope complexity	Low	0			
Deck design	High risk	4			
Total Risk Score:		8			

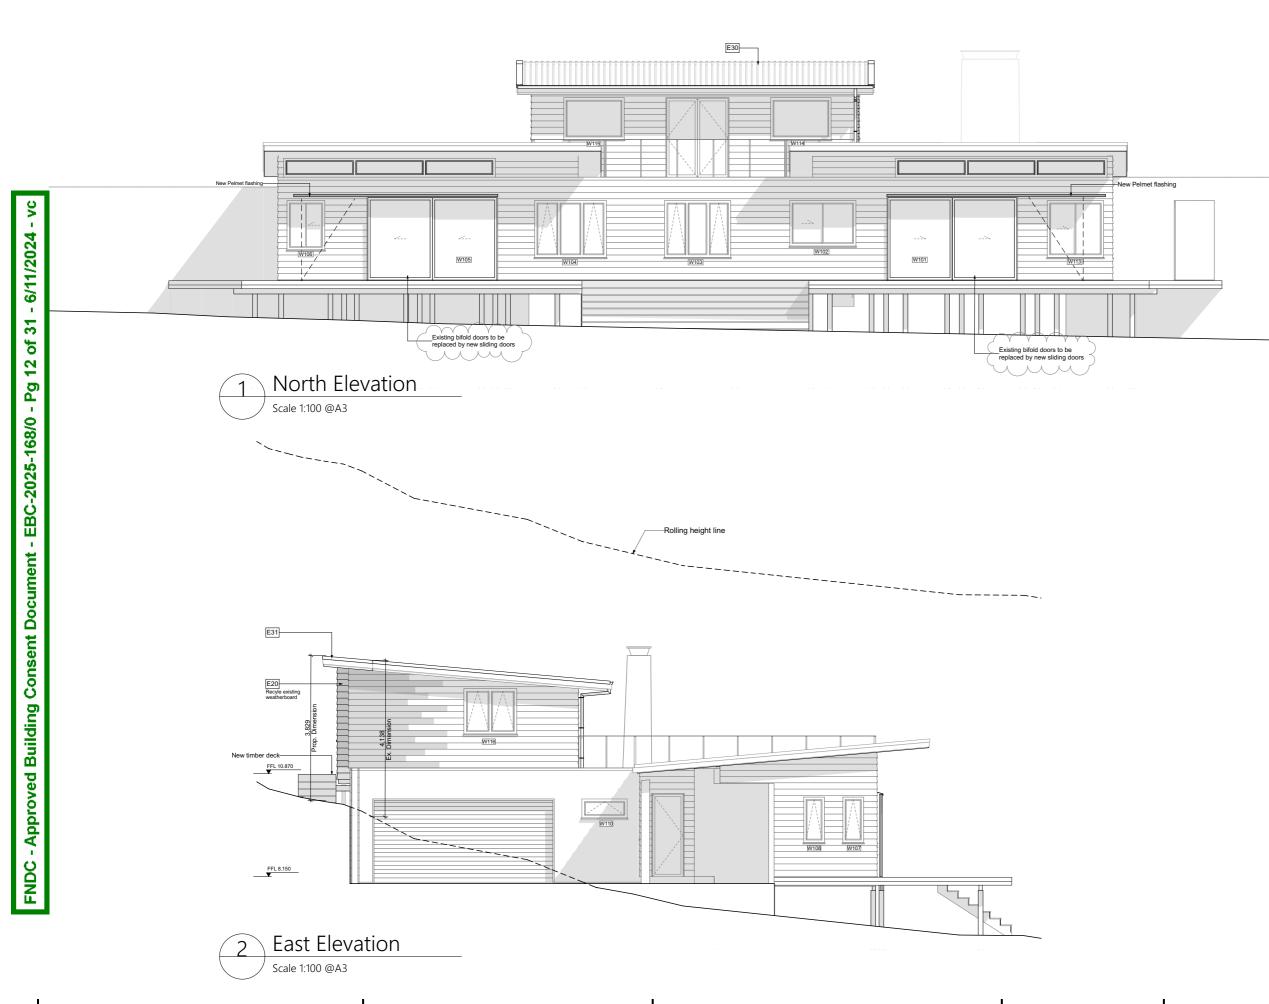BUILDING ENVELOPE RISK MATRIX

BUILDING ENVELOPE RISK MATRIX				
West Elevation				
Risk Factor	Risk Severity	Risk Score		
Wind zone (per NZS 3604)	High risk	1		
Number of storeys	High risk	2		
Roof/wall intersection design	Low risk	0		
Eaves width	Medium risk	1		
Envelope complexity	Low	0		
Deck design	High risk	4		
Total Risk Score:		8		

Eady Family Additions & Alterations at Oruruhoa Bay, Rawhiti Northland 0184

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Project No. Drawn By #Contact ID 24012 Date

28 AUG 24

Checked By

Drawing Title Elevation Drawing issue


Building Consent


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Title Rev Date 10/10/2024... BC RFI 17/09/2024... BC RFI





Section BB Scale 1:50 @A3
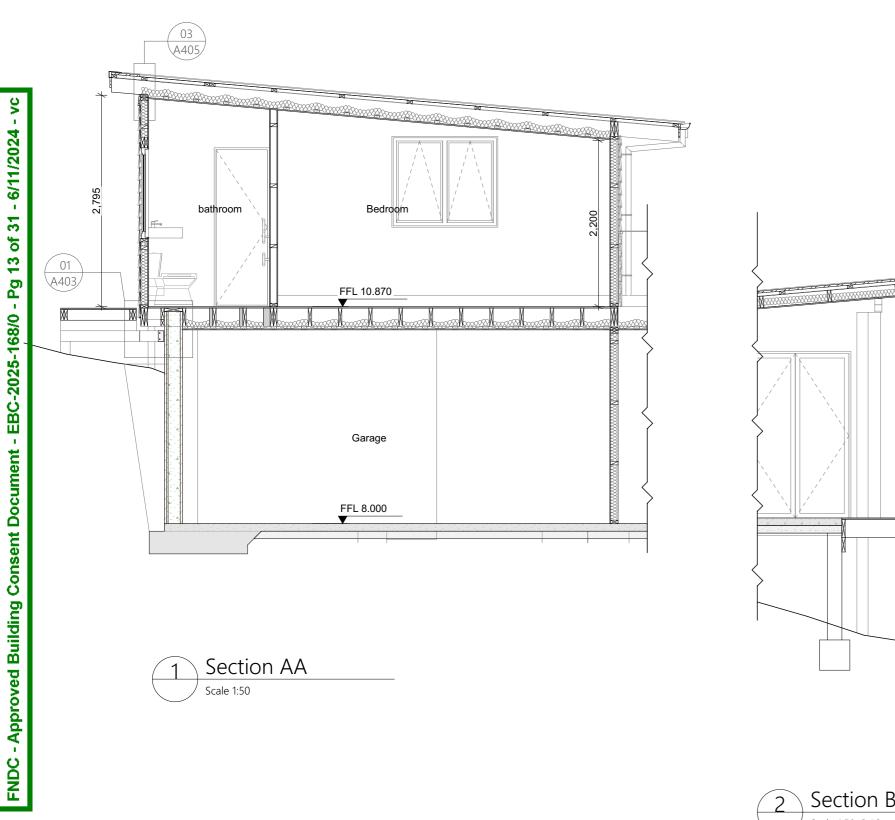
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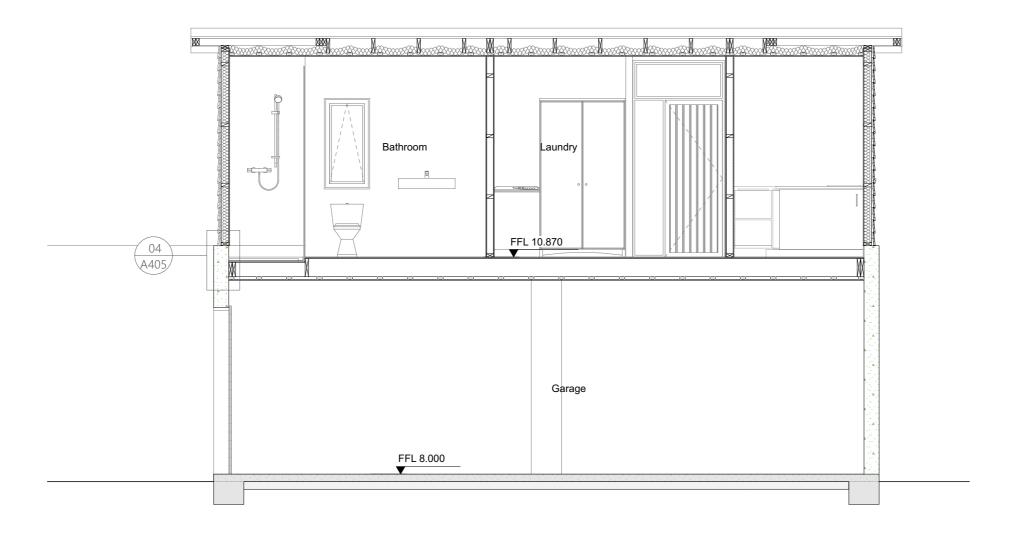
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1:50

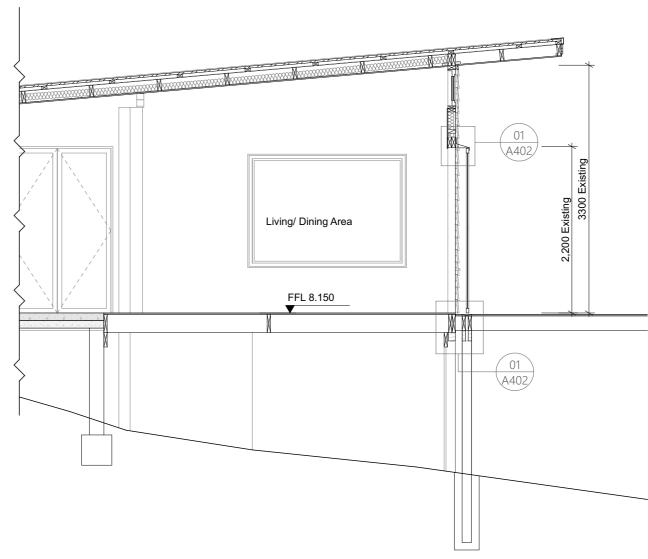@A3

Drawing Number A301

Rev Date 4/11/2024 ... BC RFI 10/10/2024... BC RFI 17/09/2024... BC RFI





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Project No. 24012 Date

28 AUG 24

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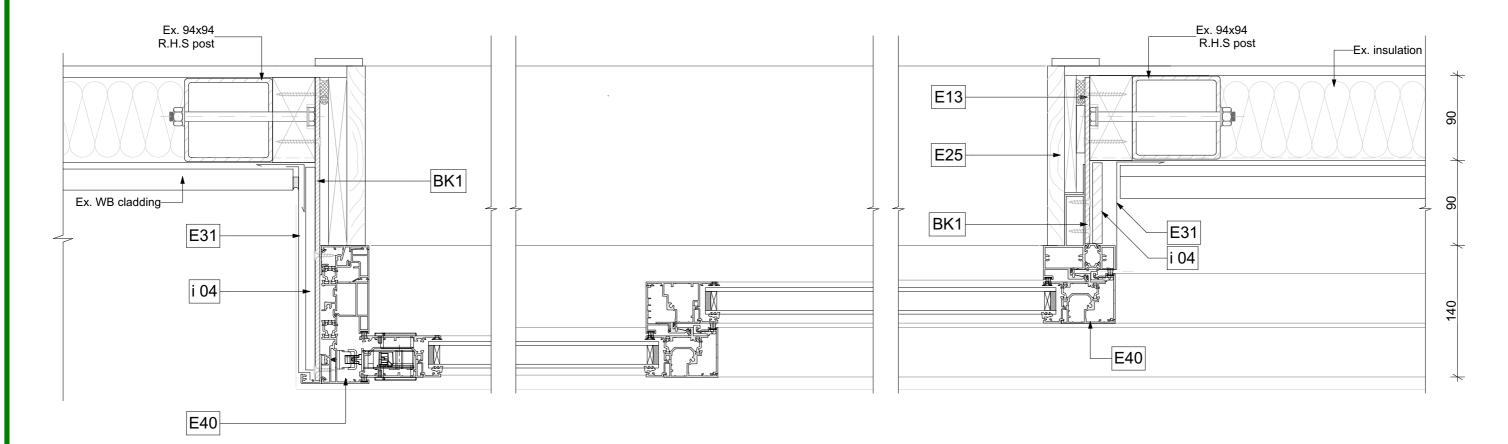
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@A3

Drawing Number A302

Rev Date 4/11/2024 ... BC RFI 10/10/2024... BC RFI 17/09/2024... BC RFI



Door Jamb Detail

Scale 1:4 @A3

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Project No. 24012 Date

28 AUG 24

Drawn By #Contact ID

Drawing Title Drawing issue Checked By

Building Consent


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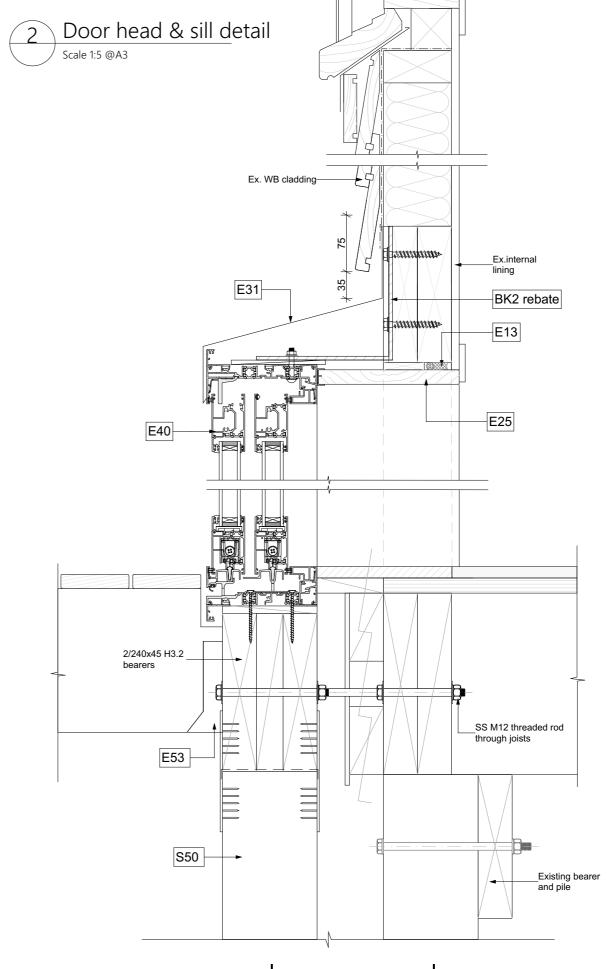
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Drawing Number A401 Rev Date 4/11/2024 ... BC RFI





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Project No. 24012 Date

28 AUG 24
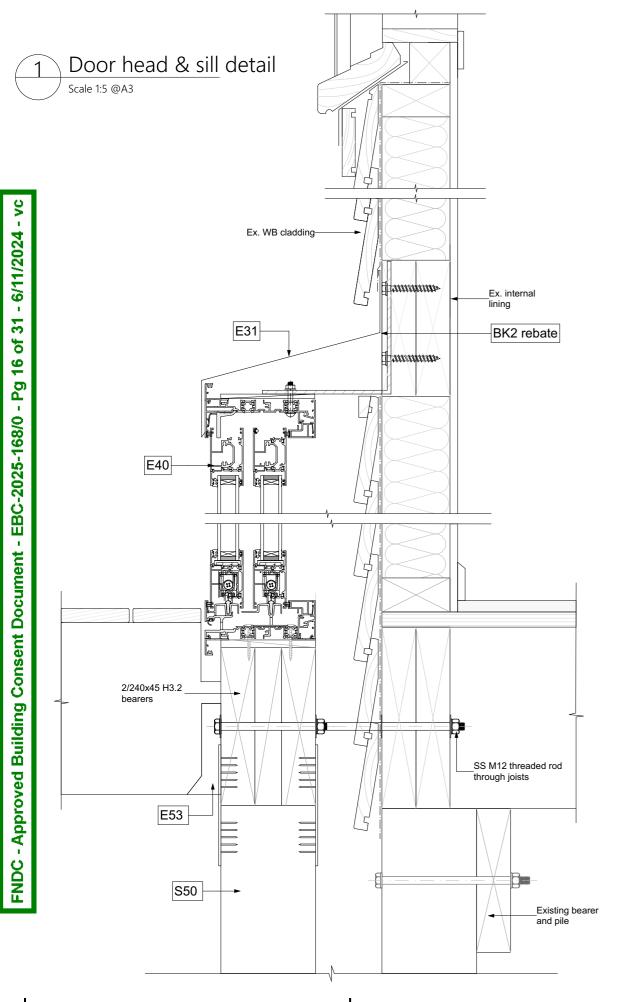
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Drawn By

Drawing issue Checked By **Building Consent**


Drawing Title Sliding door Head & Sill details

Drawing Scale:

1:5

@A3

Drawing Number A402 Rev Date 4/11/2024 ... BC RFI 14/10/2024... BC RFI

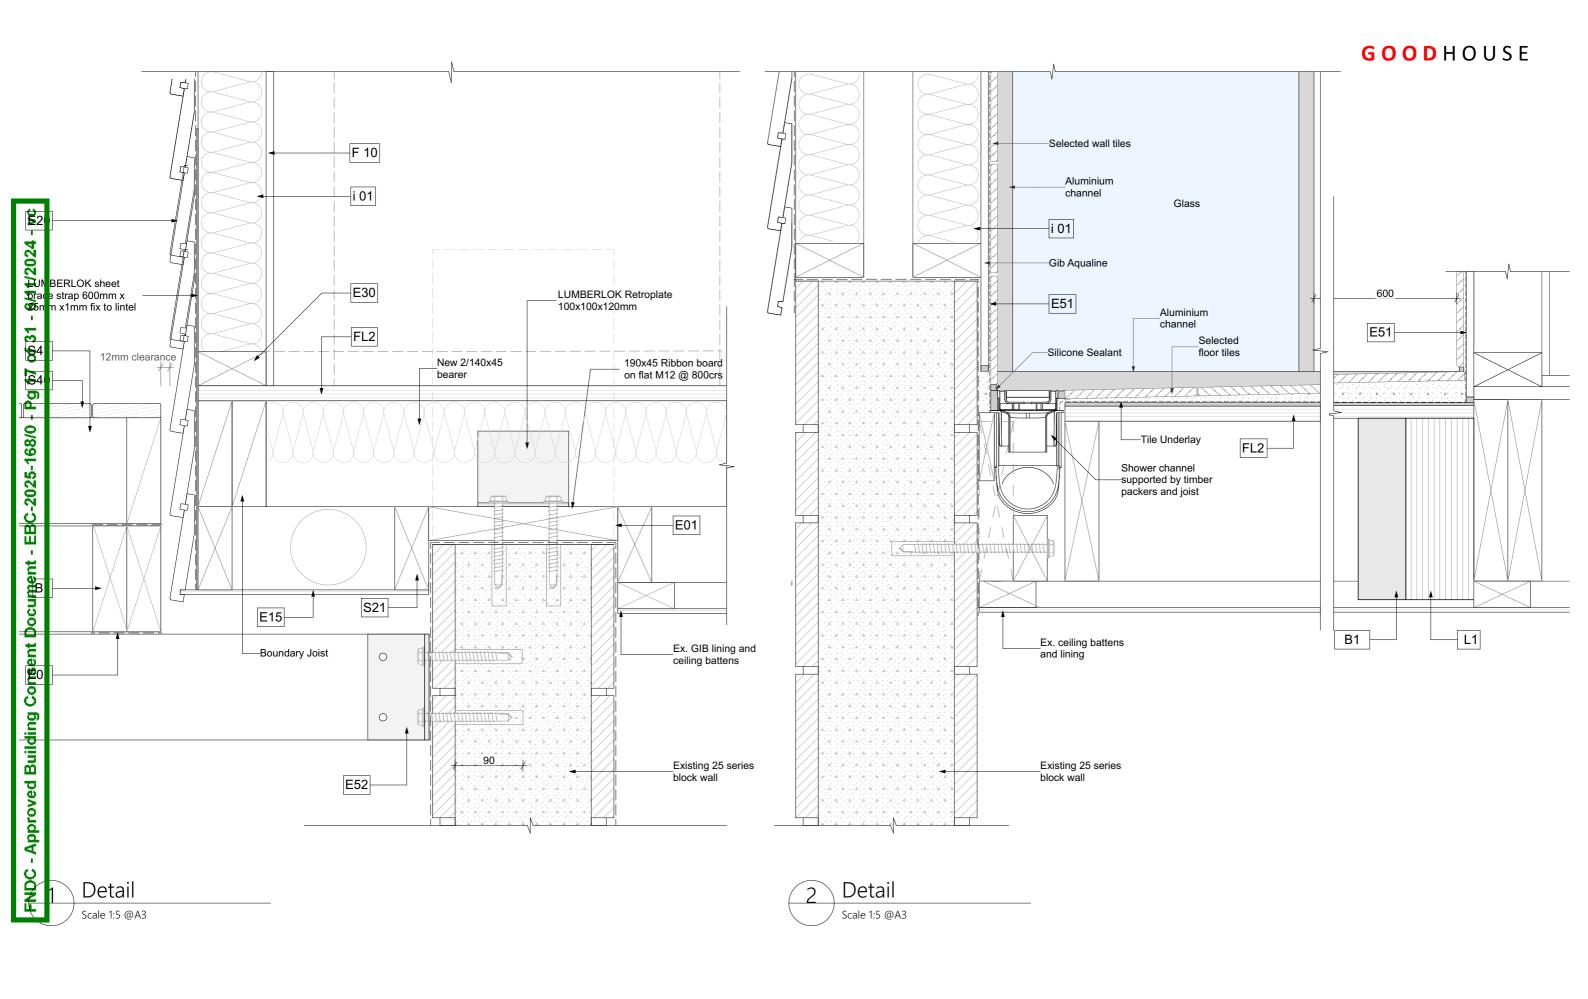

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Project No. 24012 Date

28 AUG 24

Drawn By #Contact ID

Details Checked By **Building Consent**


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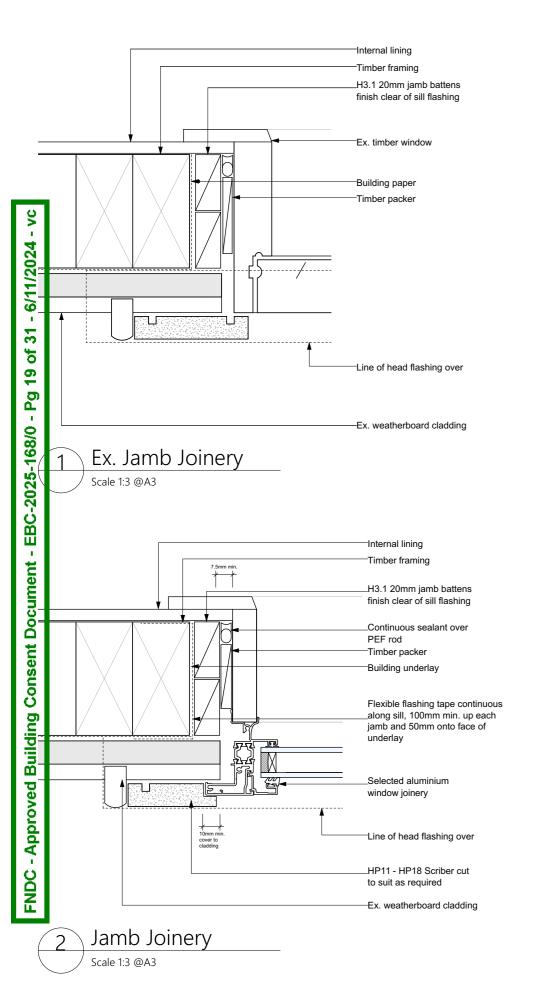
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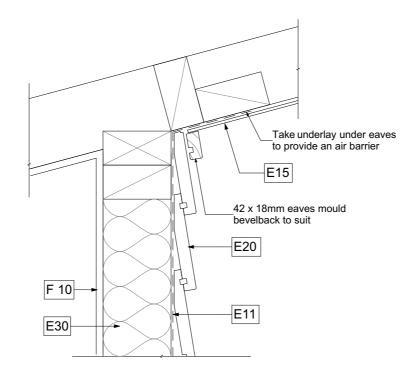
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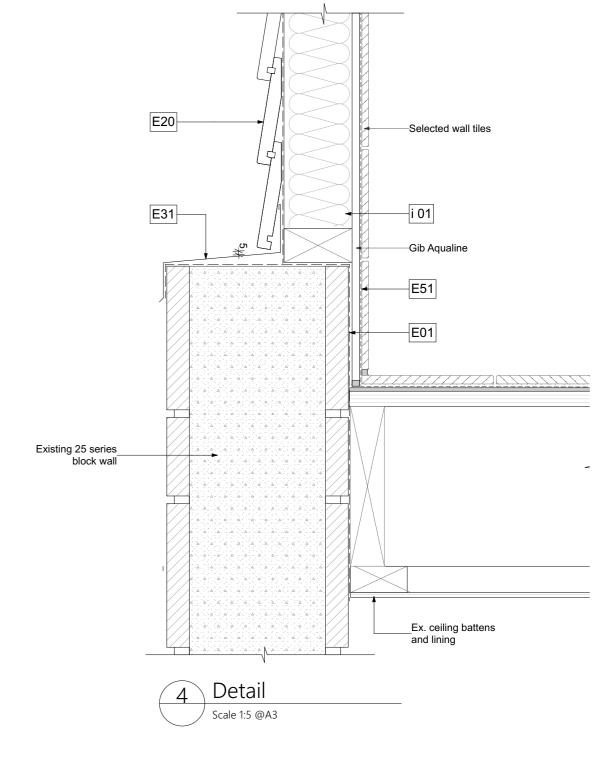
17/09/2024... BC RFI







Detail Scale 1:5 @A3

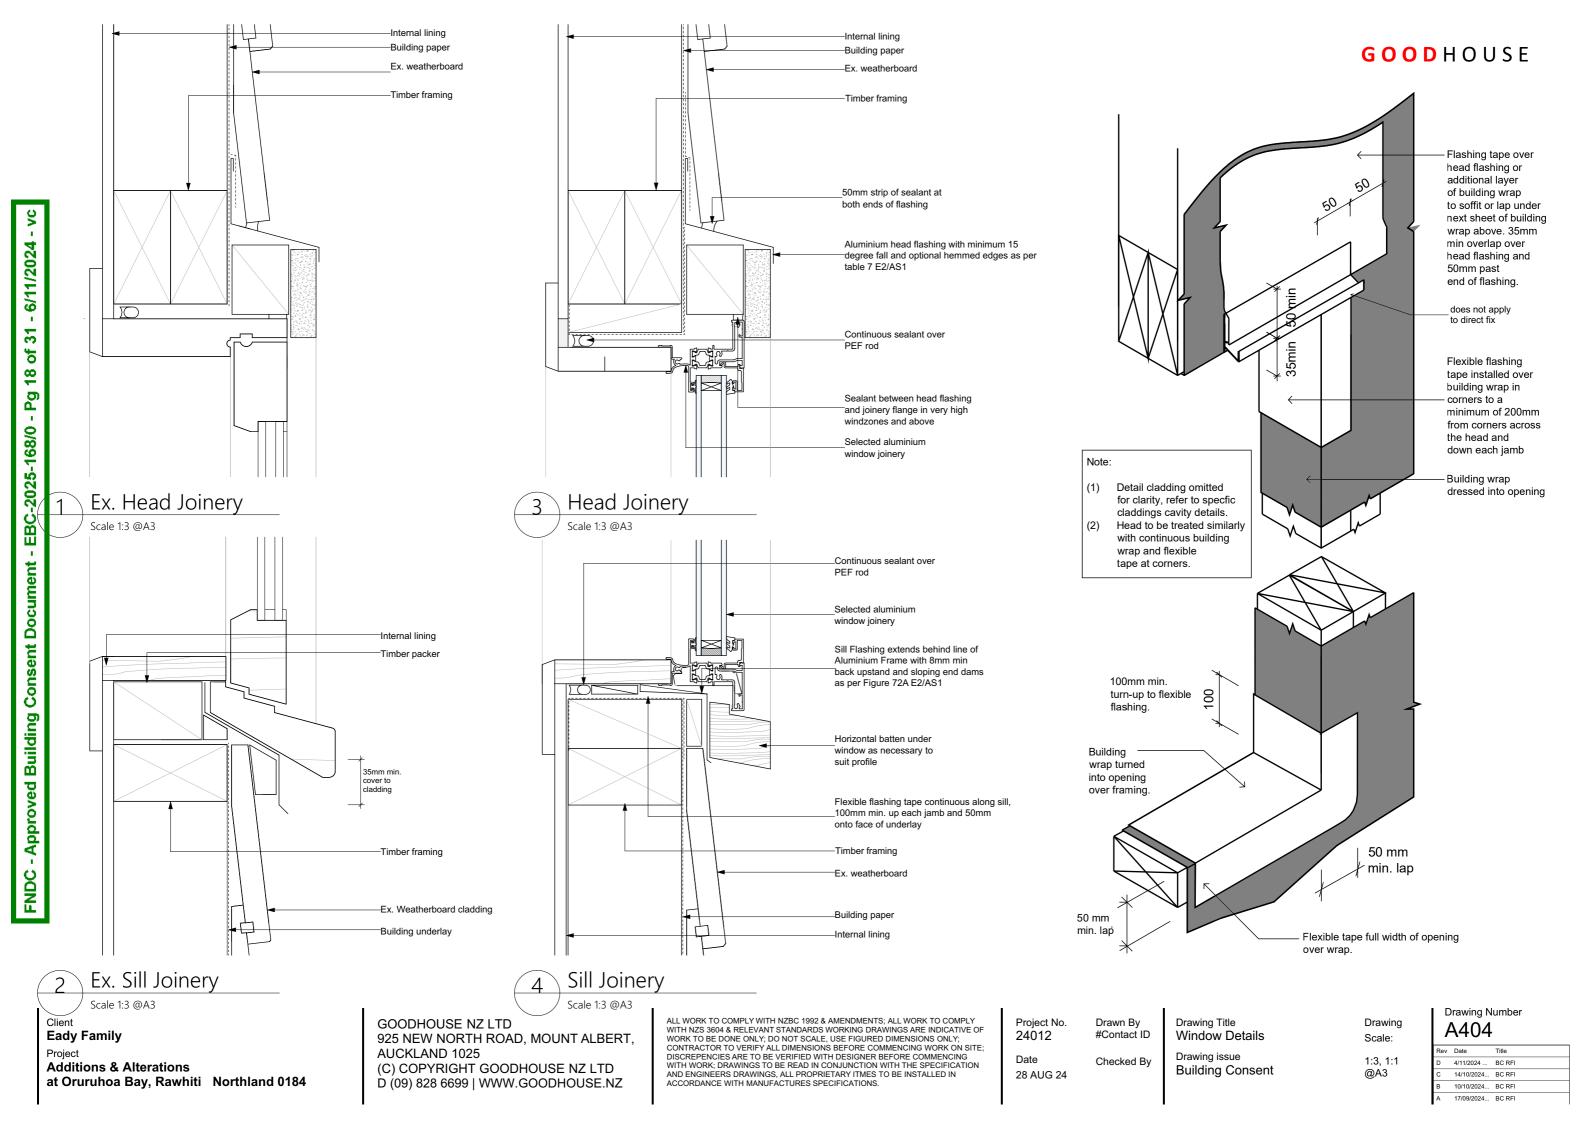


Eady Family Additions & Alterations at Oruruhoa Bay, Rawhiti Northland 0184


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Drawing Number

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BEFORE COMMENCING WORK ON SITE; DESIGNER BEFORE COMMENCING	.		Drawing issue		Rev	Date	Title	
JUNCTION WITH THE SPECIFICATION	Date	Checked By	. 3	1:3, 1:5	D	4/11/2024	BC RFI	
ARY ITMES TO BE INSTALLED IN	28 AUG 24		Building Consent	@A3	С	14/10/2024	BC RFI	
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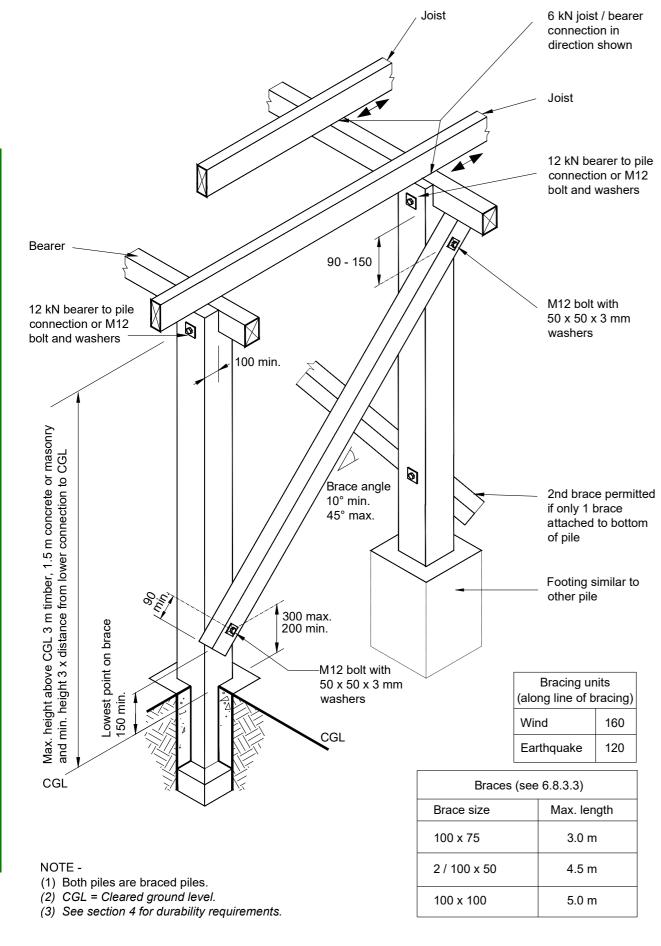
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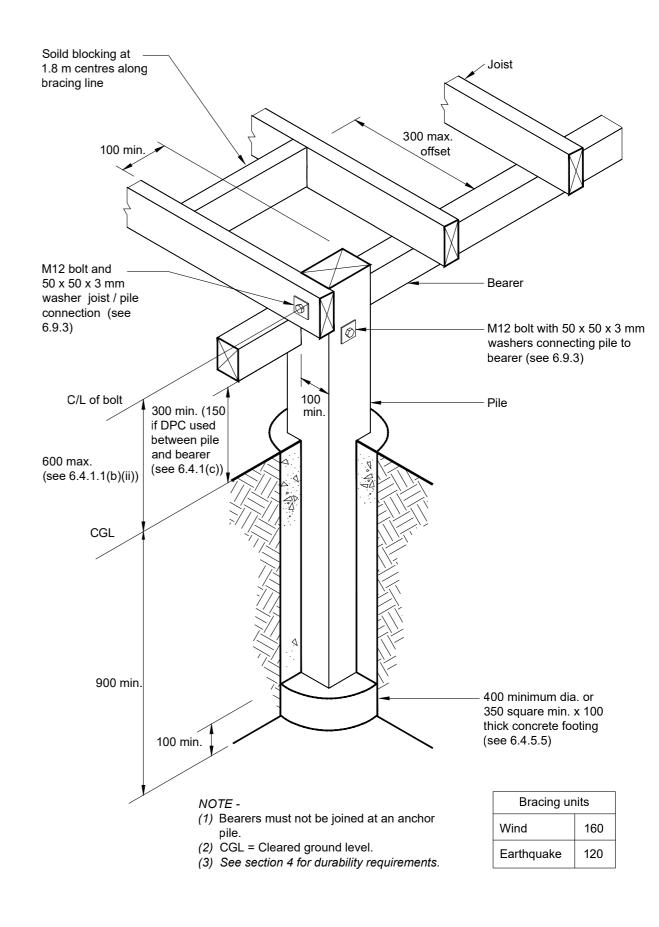
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Drawing Scale:

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Project No. 24012 Date

28 AUG 24
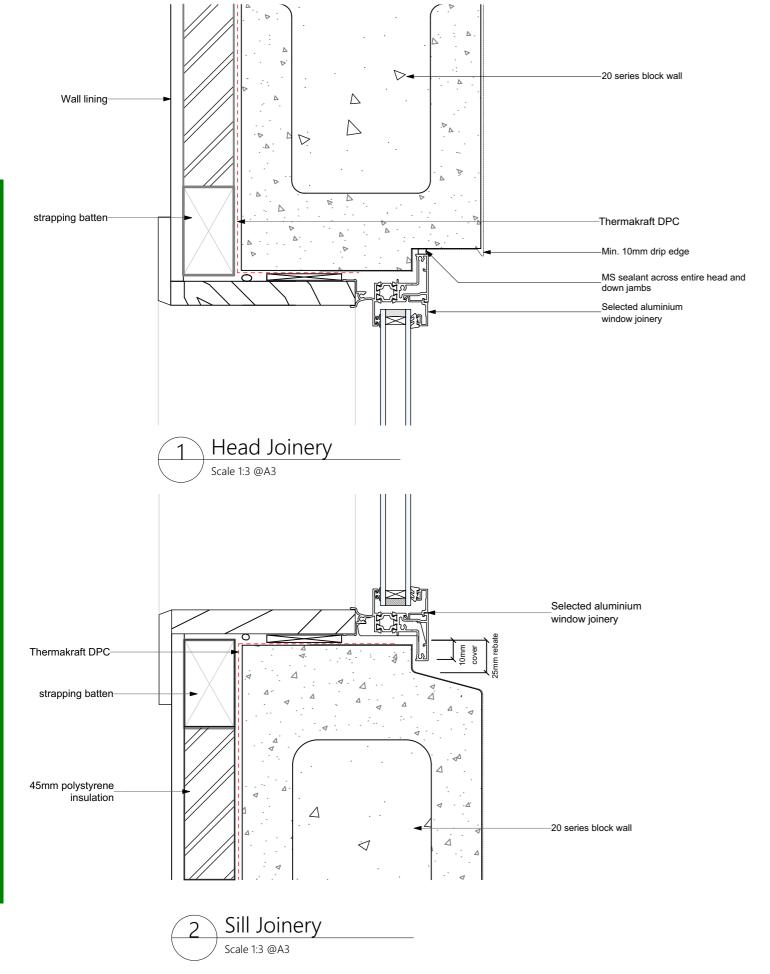
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Drawing Title **Foundation Details** Drawing issue

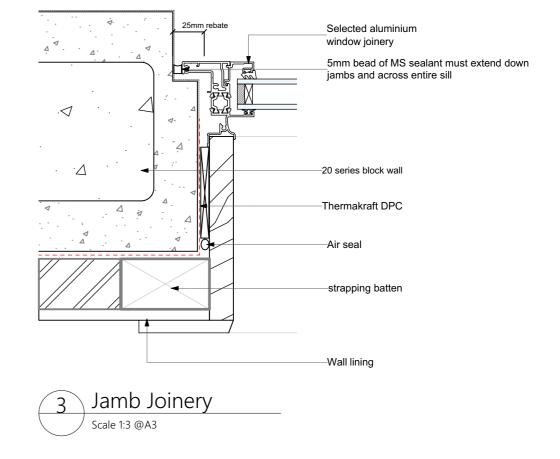Building Consent

Drawing Scale: 1:1.2777

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Drawing Number A501 ev Date 4/11/2024 ... BC RFI 14/10/2024... BC RFI

01/2012



08/2017


STUD TO TOP PLATE FIXING SCHEDULE

ALTERNATIVE TO TABLE 8.18 NZS 3604:2011

NOTE:

- ★ All fixings are designed to resist vertical loads only. Dead loads include the roof weight and standard ceiling weight
- ★ Refer to Table 8.19 NZS 3604:2011 for nailing schedule to resist lateral loads.
- ★ These fixings assume the correct choice of rafter/truss to top plate connections have been made.
- ★ For gable end walls where the adjacent rafter/truss is located within 1200mm and with a maximum verge overhang of 750mm, select stud to top plate fixing using a loaded dimension of 1.5m.
- ★ All fixings assume top plate thickness of 45mm maximum.
- ★ Wall framing arrangements under girder trusses are not covered in this schedule.
- ★ All timber selections are as per NZS 3604:2011.

LOADED DIMENSION DEFINITION

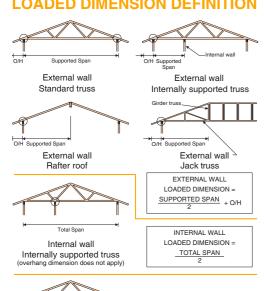

FIXING SELECTION CHART

Multiple internal walls

MULTIPLE INTERNAL WALL LOADED DIMENSION FOR

able for walls supporting roof members at 600, 900 or 1200mm crs.) Wind Zones L. M. H. VH, EH, as per NZS 3604:2011

	d Dimens tud Centre				ght Ro nd Zo					avy F nd Zo		
300mm	400mm	600mm	L	М	Н	VH	EH	L	М	Н	VH	ΕH
3.0	2.3	1.5	Α	Α	В	В	В	Α	Α	В	В	В
4.0	3.0	2.0	Α	Α	В	В	В	Α	Α	В	В	В
5.0	3.8	2.5	Α	В	В	В	В	Α	Α	В	В	В
6.0	4.5	3.0	Α	В	В	В	В	Α	Α	В	В	В
7.0	5.3	3.5	Α	В	В	В	В	Α	Α	В	В	В
8.0	6.0	4.0	Α	В	В	В	В	Α	Α	В	В	В
9.0	6.8	4.5	В	В	В	В	В	Α	Α	В	В	В
10.0	7.5	5.0	В	В	В	В	В	Α	Α	В	В	В
11.0	8.3	5.5	В	В	В	В	В	Α	Α	В	В	В
12.0	9.0	6.0	В	В	В	В	В	Α	Α	В	В	В

FIXING OPTIONS

FIXING TYPE A 0.7kN

2 x 90mm x 3 15 dia plain steel wire nails driven vertically into stud



4.7kN

FIXING TYPE B CHOOSE ANY OF THE 3 OPTIONS BELOW



2 x 90mm x 3.15 dia. plain steel








2 x 90mm x 3.15 dia. plain steel

wire nails driven vertically into stud.

2 x LUMBERLOK

Recommended for internal wall options to avoid lining issues

2 x 90mm x 3 15 dia plain steel

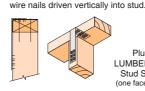

LUMBERLOK

6kN Stud Anchor

LUMBERLOK Stud Strap

To calculate the number of B type fixings required, divide the wall length by the stud centres, add 1 to this figure and locate this number of fixings as evenly as possible along the wall length. This figure includes the start and end studs in each wall length.



SCAN FOR INSTALLATION **VIDEO**

https://vimeo.com/117353604

MiTek New Zealand Limited


MiTek® MITEK® LUMBERLOK® BOWMAC®

LUMBERLOK®


FLOOR JOIST STIFFENER


- Suitable for running pipes/ducting through joists
- Maintains timber joist strength and stiffness
- ★ Allows flexibility of hole location within specific areas
- ★ Able to be retro fitted after pipes/ducting are installed
- ★ One stock item for all floor joist sizes


NOT TO BE USED IN **EXTERIOR SITUATIONS**

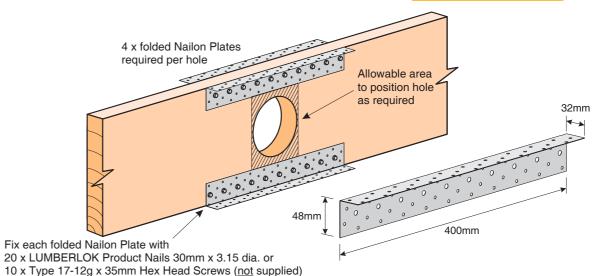

48mm

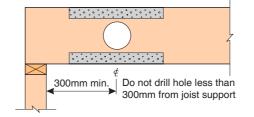

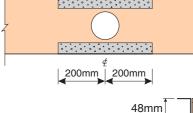

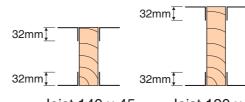

Joist 140 x 45 Joist 190 x 45 Max. 76mm hole Max. 126mm hole FJS

Material: 1.55mm G300 Z275 Galvanised Steel 8 x Folded Nailon Plate per Carton Packed:



Code:

MiTek New Zealand Limited

Drawing

Scale:

Joist 290 x 45

Max. 126mm hole

Eady Family Additions & Alterations at Oruruhoa Bay, Rawhiti Northland 0184

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Project No. Drawn By #Contact ID 24012

Date Checked By 28 AUG 24

Drawing Title LUMBERLOK Joist Stiffener & Top Plate Fixing

Drawing issue

Building Consent

Joist 240 x 45

Max. 126mm hole

@A3

Drawing Number A502 Rev Date 4/11/2024 . .. BC RFI

14/10/2024... BC RFI 10/10/2024... BC RFI 17/09/2024... BC RFI 01/2017

Heavy Roof


LINTEL FIXING SCHEDULE

ALTERNATIVE TO TABLE 8.14 & FIGURE 8.12 NZS 3604:2011

NOTE:

- ★ All fixings are designed for vertical loads only. Dead loads include the roof weight and standard ceiling weight of 0.20kPa.
- ★ Refer to Table 8.19 NZS 3604:2011 for nailing schedule to resist horizontal loads.
- ★ These fixings assume the correct choice of rafter/truss to top plate connections have been made.
- ★ All fixings assume bottom plate thickness of 45mm maximum. Note: TYLOK options on timber species.
- ★ Wall framing arrangements under girder trusses are not covered in this schedule.
- ★ All timber selections are as per NZS 3604:2011.

DEFINITIONS

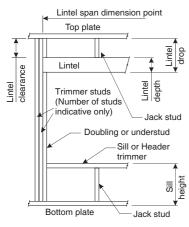

Lintel Supporting Girder Trusses								
Roof Tributary	L	ight Roo	of	Н	eavy Ro	of		
Area	V	Vind Zon	ie	٧	Vind Zon	ie		
	L, M, H	VH	EH	L, M, H	VH	EH		
8.6m²	G	G	Н	G	G	Н		
11.6m²	G	Н	Н	G	G	Н		
12.1m ²	G	Н	Н	G	Н	Н		
15.3m²	Н	Н	-	G	Н	Н		
19.1m²	Н	-	-	G	Н	-		
20.9m ²	Н	-	-	Н	Н	-		
21.8m ²	Н	-	-	Н	-	-		
34.3m ²	-	-	-	Н	-	-		

NOTES:

MiTek

- 1. Roof Tributary Area = approx. 1/2 x (Total roof area on girder and rafte) trusses supported by lintel)
- 2. Assumed girder truss is at mid-span or middle third span of lintel
- 3. Use similar fixings for both ends of lintel
- 4. All other cases require specific engineering design


Lintel	Loaded			nd Zo					nd Z		
Span	Dimension (m)		VVII	IU Z	JITE			VVI	iiu Z	JIIE	
(m)	(See Fig. 1.3	L	М	Н	VH	EΗ	L	М	Н	VH	EΗ
()	NZS 3604:2011)	_									
	2.0	Е	Ε	Ε	F	F	Е	Ε	Ε	Ε	F
	3.0	Е	Е	F	F	F	Е	Ε	Е	F	F
1.0	4.0	Е	F	F	F	G	Е	Ε	F	F	F
	5.0	Е	F	F	G	G	Е	Е	F	F	G
	6.0	Е	F	F	G	G	Е	Е	F	F	G
	2.0	Е	Е	F	F	F	Е	Е	Е	F	F
	3.0	E	E	F	F	F	E	E	F	F	F
1.2	4.0	E	F	F	G	G	E	Ē	F	F	G
	5.0	Ē	F	F	G	G	Ē	Ē	F	F	G
	6.0	F	F	G	G	Н	E	E	F	G	G
	2.0	Ė	E	F	F	F	E	Ē	E	F	F
	3.0	Ē	F	F	F	G	Ē	Ē	F	F	F
1.5	4.0	Ē	F	F	G	G	E	Ē	F	F	G
1.5	5.0	F	F	G	G	Н	E	E	F	G	G
		F	F		Н	Н	E				
	6.0	E	F	G	F			E	F	G	H
	2.0		F	F		G	E	E	F	F	
0.0	3.0	E	F		G	G	E	E	F		G
2.0	4.0			G	G	Н	E	E		G	G
	5.0	F	F	G	Н	Н	E	E	F	G	Н
	6.0	F	G	G	Н	Н	Е	F	G	Н	Н
	2.0	Е	F	F	G	G	Е	Е	F	F	G
	3.0	F	F	G	G	Н	Е	Е	F	G	G
2.4	4.0	F	F	G	Н	Н	Е	Е	F	G	Н
	5.0	F	G	G	Н	Н	Е	F	G	Н	Н
	6.0	F	G	Н	Н	-	Е	F	G	Н	Н
	2.0	Е	F	F	G	G	Е	Е	F	F	G
	3.0	F	F	G	Н	Н	Е	Ε	F	G	Н
3.0	4.0	F	G	G	Н	Н	Е	F	G	Н	Н
	5.0	F	G	Н	Н	-	Е	F	G	Н	Н
	6.0	F	G	Н	-	-	Е	F	G	Н	-
	2.0	F	F	G	G	Н	Е	Е	F	G	G
	3.0	F	F	G	Н	Н	E	F	G	G	Н
3.6	4.0	F	G	Н	Н	-	E	F	G	Н	Н
0.0	5.0	F	G	Н	-	-	E	F	G	Н	-
	6.0	G	Н	Н	-	-	E	F	Н	-	-
	2.0	F	F	G	G	Н	Ē	Ē	F	G	G
	3.0	F	G	Н	Н	-	E	F	G	Н	Н
4.2	4.0	F	G	Н	-	-	E	F	G	Н	-
7.2	5.0	G	Н	Н	-		Ē	F	Н		
	6.0	G	Н	-	-	-	E	F	Н	-	-
	2.0	F	F	G	Н	Н	Ē	E	F	G	Н
	3.0	F	G	Н	Н	-	E	F	G	Н	Н
	3.4	F	G	Н	Н	-	E	F	G	Н	Н
4.5	4.0	F	G	Н	17	H	E	F	G	Н	11
		G			-	-	E	F	Н		-
	5.0	G	H	-	-	-	E	F	Н	-	-
	6.0	F	F	G	- H			-	F		
	2.0	F				Н	E	E		G	Н
	3.0	F	G	Н	Н	-	E	F	G	Н	Н
4.8	3.2	F	G	Н	Н	-	E	F	G	Н	Н
-	4.0	F	G	Н	-	-	Ε		Н	Н	-
	5.0	G	Н	-	-	-	E	F	Н	-	-
	6.0	G	Н	-	-	-	Е	F	Н	-	
	2.0	F	F	G	Н	Н	Е	F	G	G	Н
	3.0	F	G	Н	Н	-	Е	F	G	Н	Н
5.1	3.5	F	G	Н	-	-	Е	F	G	Н	-
J. I	4.0	G	G	Н	-	-	Е	F	Н	Н	-
	5.0	G	Н	-	-	-	Е	F	Н	-	-
	6.0	G	Н	-	-	-	Е	G	Н	-	-
	2.0	F	F	G	Н	Н	Е	F	G	G	Н
	2.8	F	G	Н	Н	-	Е	F	G	Н	Н
	3.0	F	G	Н	-	-	Ē	F	G	Н	-
5.4	4.0	G	Н	Н	-	-	Ē	F	Н	-	-
					-		Ē	F	Н	-	-
	5.0	G	Н	-		-					


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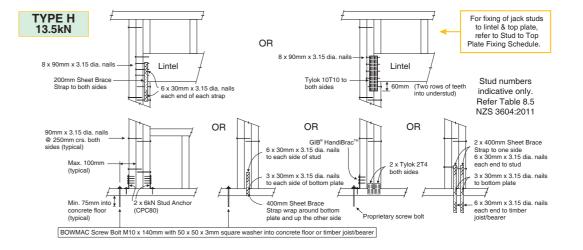
Light Roof

LINTEL FIXING OPTIONS





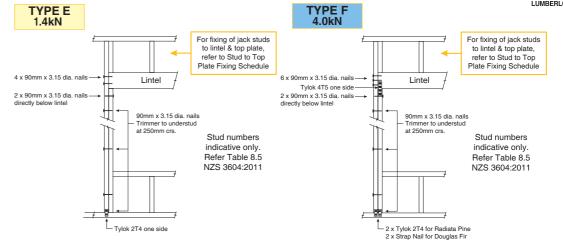

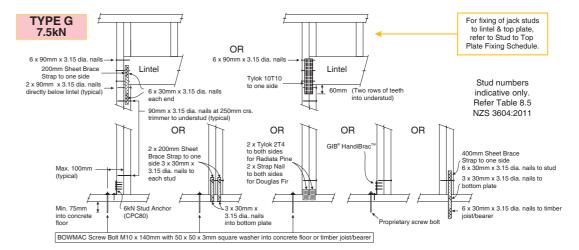



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Project No. Drawn By #Contact ID 24012 Date

28 AUG 24

Checked By Drawing issue

Drawing Title LUMBERLOK Lintel Fixing Schedule

Building Consent

Scale:

@A3

A503 Rev Date 4/11/2024 BC RFI 14/10/2024... BC RFI

Eady Family Additions & Alterations at Oruruhoa Bay, Rawhiti Northland 0184

Drawing Number Drawing

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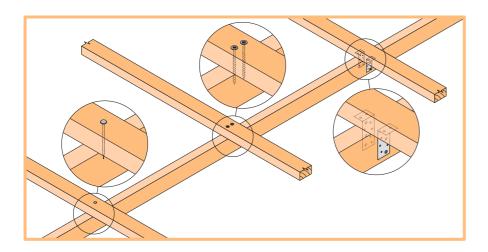


PURLIN & BATTEN FIXING CHART

ALTERNATIVE SOLUTION TO NZS 3604:2011 TABLES 10.10 & 10.12

NOTE:

- ★ All purlin and batten sizes are as per NZS 3604:2011.
- ★ All fixings assume that the purlin and battens are installed on their flat over the top of the rafter or truss.
- ★ The minimum fixing requirements apply to all purlin locations within the roof area.
- ★ The LUMBERLOK BLUE SCREW where specified requires a minimum of 30mm penetration into rafter or truss i.e. it is suitable for rough sawn timber up to 50mm thick at 18% moisture content.



SELECTION CHART FIXING OPTIONS

(minimum fixing requirements)

DOOF WEIGHT	MAX.	MAX.		W	IND ZON	IE	
ROOF WEIGHT	F WEIGHT PURLIN SPAN PURLIN CRS. (mm) (mm)		L	М	Н	VH	EH
HEAVY ROOF Tile Battens	900	370	Α	Α	Α	Α	Α
LIGHT ROOF	900	370	Α	Α	В	С	С
Tile Battens	1200	370	Α	В	С	С	С
	900	900	С	С	С	С	D
LIGHT ROOF Purlins	1200	900	С	С	С	D	D
	1200	1200	С	С	D	E	Е


L = Low Wind M = Medium Wind Wind Zone: = High Wind As per NZS 3604:2011 VH = Very High Wind EH = Extra High Wind




SCAN FOR INSTALLATION **VIDEO**

https://vimeo.com/117353340

STANDARD FIXING OPTIONS

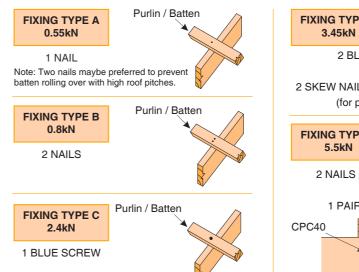

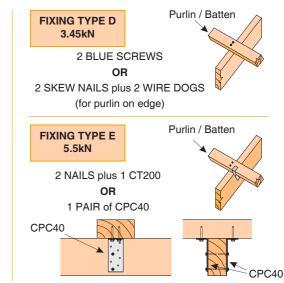

FIXING DEFINITIONS

NAIL = Either 90mm x 3.15 dia. power-driven nail or 100mm x 3.75 dia. hand-driven nail

BLUE SCREW = 80mm x 10 gauge LUMBERLOK BLUE SCREW


WIRE DOG = LUMBERLOK WIRE DOG either LH or RH

CT200 = LUMBERLOK Ceiling Tie CT200 bend over purlin, 4 x LUMBERLOK Product Nails 30mm x 3.15 dia. each end

CPC40 = LUMBERLOK CPC40 with 2 x Type 17 - 14g x 35mm Hex Head Screws per flange

FIXING TOLERANCES

LUMBERLOK BLUE SCREW

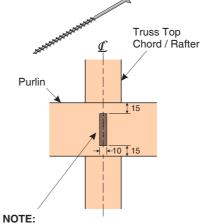

Locate fixings within the shaded area. Care to be taken to avoid over tightening of screws.

PURLIN / BATTEN SPLICE FIXING OPTIONS

FIXING TYPE A & B OVER **PURLIN SPLICE**

NOTE:

Skew nail when fixing to 35mm rafter or truss

90 x 35mm block fixed

to chord or rafter with

4 x 75mm nails

FIXING TYPE C, D or E OVER **PURLIN SPLICE**

• TYPE C 1 SCREW to each purlin

• TYPE D & E 1 NAIL plus 1 SCREW to each purlin



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Project No. Drawn By #Contact ID 24012

Date Checked By 28 AUG 24

Drawing Title LUMBERLOK Purlin & Batten

Building Consent


Fixing Detail Drawing issue

Drawing Number Drawing A504

Rev	Date	Title	
D	4/11/2024	BC RFI	
С	14/10/2024	BC RFI	
В	10/10/2024	BC RFI	
Α	17/09/2024	BC RFI	

Roof Plane & Roof Space Brace Requirements Flow Chart



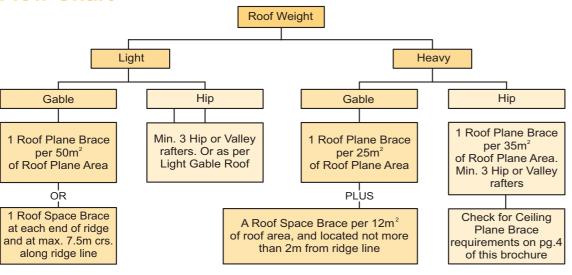

Roof Plane Brace & Installation Single tensioned crossed LUMBERLOK Strip Brace over top chords/rafters 5 / 30 x 3.15 nails each end 5 / 30 x 3.15 nails **Alternative Layout Options** 1 / 30 x 3.15 nail Single Cross @ 45° at crossing When purlin depth above truss chord is 50mm or less, Strip Brace can be installed over top of Double Cross @ 45° Quadruple Cross @ 45°

SECTION 4 - DURABILITY

NZS 3604:2011

Table 4.1 - Protection required for steel fixings and fastenings excluding nails and screws(1) (see 4.4.1)

ZONES	FIXING FASTENING	ENVIRONMENT		MATERIAL				
	Nail plates	CLOSED AND		0200257115		CLOSED AND		Continuously coated galvanized steel ⁽²⁾
ALL ZONES	Wire dogs & bolts	ROOF SPACES		Hot-dipped galvanized steel ⁽²⁾				
	All other structural fixings	CLOSED		CLOSED		CLOSED		Mild steel (uncoated, non-galvanized)(3)
ZONE D	All structural fixings	SHELTERED ⁽⁴⁾ AND EXPOSED				Type 304 stainless steel ⁽⁵⁾		
	Treated timber pile connections more	Subfloors vented 7000 mm ² or less	SHELTERED ⁽⁴⁾	Hot-dipped galvanized steel ⁽²⁾				
	than 600 mm from the ground and all subfloor connections	Subfloors vented more than 7000 mm ²	EXPOSED	Type 304 stainless steel ⁽⁵⁾				
ZONES B AND C	Treated timber pile connections within 600 mm of the ground	SHELTERED ⁽⁴⁾ AND EXPOSED		Type 304 stainless steel ⁽⁵⁾				
	All other structural	SHELTERED ⁽⁴⁾	Hot-dipped galvanized steel ⁽²⁾					
	fixings, except fabricated brackets ⁽⁶⁾	EXPOSED	Type 304 stainless steel ⁽⁵⁾					

- (1) Items described in this table are steel fasteners required to last not less than 50 years, used for joining timber, such as nail plates, bolts, brackets, wire dogs and similar, but not including nails or screws (which are described in table 4.3).
- (2) All galvanizing weights to steel shall be as given in table 4.2.
- (3) Steel fixings in timber treated with copper-based timber preservatives shall be as per $\underline{4.4.4}$.
- (4) "Sheltered" shall be that above a 45° line drawn from the lower edge of a projecting weathertight structure such as a floor, roof or deck. "Exposed" shall be below that 45° line. See <u>figure 4.3(a)</u> and <u>(b)</u>.
- (5) Type 304 stainless steel is sufficient to comply with <u>NZBC</u> requirements, but may have surface rust. Type 316 may be used where appearance is a consideration but exceeds the requirements of the <u>NZBC</u>.
- (6) "Fabricated brackets" shall be made from 5 mm (minimum thickness) mild steel and shall be hot-dipped galvanized.

4.4.2

Galvanized steel components shall have galvanized coating masses in accordance with table 4.2.

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Client
Eady Family
Project
Additions & Alterations
at Oruruhoa Bay, Rawhiti Northland 0184

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Project No. Drawn By 24012 #Contact ID

Date Checked By

28 AUG 24

Drawing Title
Roof Bracing & Durability for
Steel Fixing/Fastenings

Building Consent


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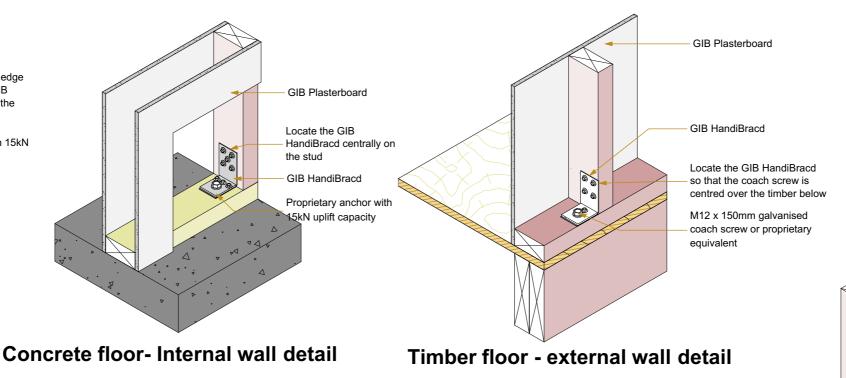
10/10/2024... BC RFI

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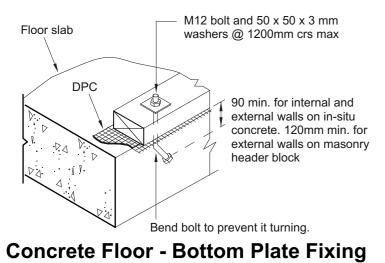


Concrete floor- external wall detail



M12 x 150mm galvanised coach screw and 50 x 50 x 3mm square galvanised washer Six 30 x 2.5mm galvanised flat head nails to each side of stud) 400 x 25 x 0.9mm galvanised strap (strap passes underneath bottom plate) Three 30 x 2.5mm galvanised flat head nails to each side of bottom plate

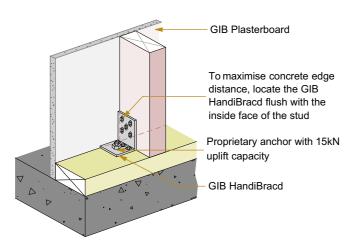Timber floor - Internal detail



Six 30 x 2.5mm galvanised flat head nails to each side of stud 400 x 25 x 0.9mm galvanised strap (strap passes underneath bottom plate) Three 30 x 2.5mm galvanised flat head nails to each side of bottom plate

Hold Down Concrete Floor

Detters plate to flees	Power-driven nails				
Bottom plate to floor faming at:	Length(mm) x diameter (mm) and type	Number / Location			
External walls and internal wall bracing elements	90 x 3.15	3 at 600 mm centres			
Internal walls (may be nailed to floor decking)	90 x 3.15	1 at 600 mm centres			
Trimmer not exceeding 4.2m long	90 x 3.15	6 (end nailed)			

arata Flaar

Timber floor - External wall Option detail

Timber floor - External wall Option detail

Jack stud to first nog

Three 30x2.5mm

head nails to plate

galvanised flat

accomodate double strap

Two 300x25x0.9mm

Galvanised straps

Six 30x2.5mm galvanised

flat head nails to each

stud and joist

fixed to

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Project No. Drawn By 24012 #Contact ID

Date Checked By 28 AUG 24


Drawing Title Framing Fixing Detail

Building Consent

Drawing issue

Drawing Scale: 1:10 Drawing Number A 506

| Rev | Date | Title | D | 4/11/2024 ... | BC RFI

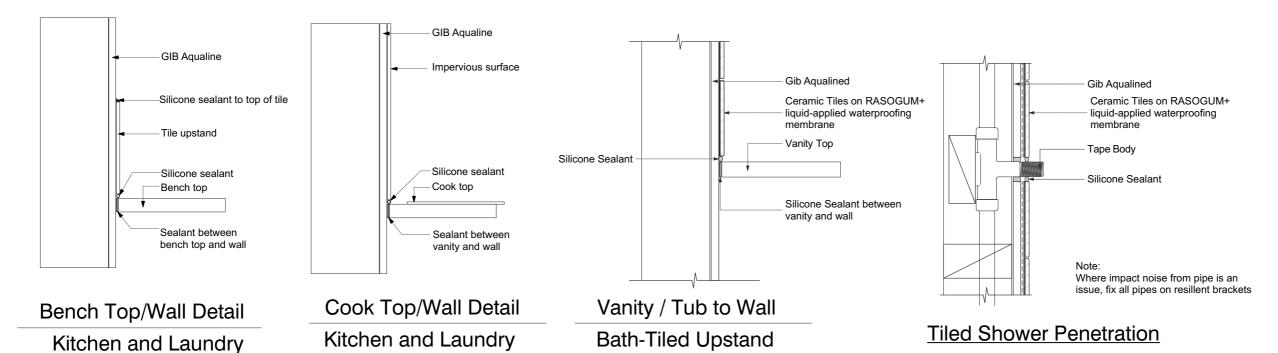

Gib Aqualine Selected Ceramic Tiles Reinforcing Mat embedded into RASOGUM+ liquid-applied waterproofing membrane 32x32x0.55mm 6mm Silicone Sealant vertical fixed Galvanised steel angle


Tiled Shower Corner - Plan

31 - 6/11/2024 - vc

of


Approved Building Consent Document - EBC-2025-168/0 - Pg 27

Gib Aqualine to wet areas, studs @ 400 Ctrs and nogs @ 600 Ctrs with Enamel paint.

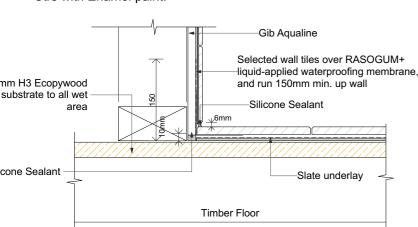

Note:

- Gib Aqualine to wet areas, studs @ 400 ctrs and nogs @ 600 ctrs with Enamel paint finish.
- Protecto Wrap AFM-WM membrane under tiles on 10mm villaboard tile underlay in showers and
- James Hardie 6mm tile underlay as floor substrate under membrane

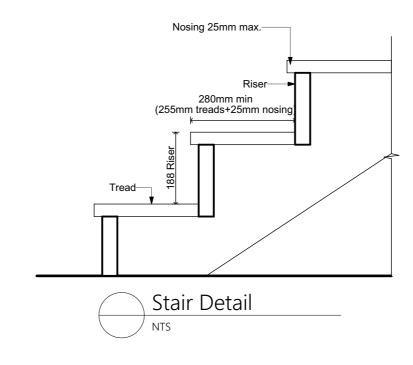

Tiled Floor and Wall - Timber Floor

Eady Family Additions & Alterations at Oruruhoa Bay, Rawhiti Northland 0184

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Project No. 24012 Date

28 AUG 24

Drawn By #Contact ID

Checked By

Drawing Title Wet Area Detail Drawing issue

Building Consent

Drawing Scale:

1:5 @A3

Drawing Number A507c Rev Date 10/10/2024... BC RFI


17/09/2024... BC RFI

GOODHOUSE

MiTek

12kN RETRO SUBFLOOR FIXING

- → Fixing to be used when the outside face of the bearer is not accessible e.g. fixing relocatable houses to piles
- → Hot Dip Galvanised or Stainless Steel options available for required corrosive zone

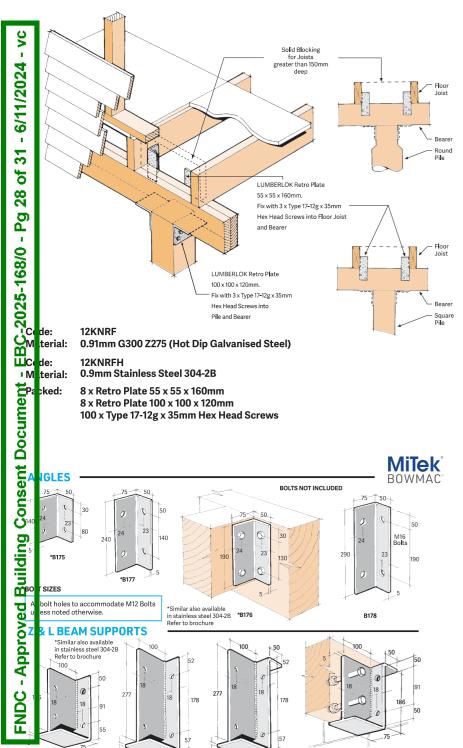

MiTek[®] LUMBERLOK[®]

SPLIT HANGERS FOR LARGER TIMBER WIDTHS **OR DOUBLE MEMBER CONNECTIONS**


OPTION IN EXTERIOR SITUATIONS. GREEN TIMBER FACTORS

IF APPLICABLE TO BE APPLIED TO PUBLISHED CAPACITIES

USE STAINLESS STEEL

2024 EDITION V1

- → Always used in pairs
- → Fill all round holes with screws first. If greater loads are required, fill all secondary square holes in addition to round holes with screws as per the table below
- → Shear capacity of timber must not be less than the applied loading to hangers
- → When both round and square holes are filled the supported beam must be a minimum of double 45mm or 90mm wide
- → Stainless Steel Screws to be used with Stainless Steel Hangers, Galvanised Screws to be used with Galvanised Hangers

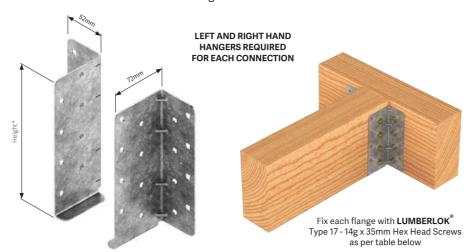

Characteristic Loads per pair of Split Hangers

	Number of		ULS Capacities [seasoned timber] Strength Reduction factor ∅ = 0.7				
Hanger Type	Screws per Flange	k1 = 0.6	k1 = 0.8	k1 = 1		Characteristic Strength in kN	
SPH140 &	3	5 kN	6.7 kN	8.4 kN		12 kN	
SSSPH140	6	10 kN	13.4 kN	16.8 kN		24 kN	
SPH180 &	4	7.1 kN	9.5 kN	11.9 kN		17 kN	
SSSPH180	8	14.2 kN	19 kN	23.8 kN		34 kN	
SPH220 &	5	9.2 kN	12.3 kN	15.4 kN		22 kN	
SSSPH220	10	18.4 kN	24.6 kN	30.8 kN		44 kN	

Material: 1.55 G300 Z275 Galvanised Steel or 1.5mm Stainless Steel 304-2B

Structural Fixings On-Site Guide 59


*Split Hangers are

SPH140 - 137mm SPH180 - 177mm SPH220 - 217mm

available in heights of:

Nailon Plate Dimensions

Nailon is manufactured from steel coil and is available in 1mm, 2mm and 3mm nominal thicknesses of widths shown. LUMBERLOK Nailon is a very versatile steel plate with many applications in timber construction, providing a very strong jointing system. Nailon is easily applied by filling the pre-punched holes with LUMBERLOK Product Nails 30mm x 3.15mm dia. or Type 17 Hex Head Screws. Flat Nailon Plate can be used for splicing trusses and beams, or as a moment joint when a pair of plates are used. 3mm Nailon can also be welded to form special brackets supporting portal frames, trusses, etc.

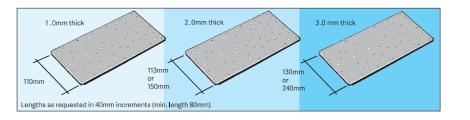

Specification

1.0mm x 110mm - 0.91mm G300 Z275 Galvanised Steel

2.0mm x 113mm or 150mm - 1.55mm G300 Z275 Galvanised Steel 3.0mm x 130mm or 240mm - Black Steel NZCC-SD ungalvanised

1.0mm and 2.0mm Nailon is zinc coated prior to punching

3.0mm Nailon is generally supplied ungalvanised, however all Nailon is available hot dipped galvanised on request

Nailon is available in 0.9mm x 110mm Stainless Steel 304-2B.

Nails and Screws

1.0mm x 110mm and 2.0mm x 113mm Nailon, 8 nails or 3 screws per 40mm length

2.0mm x 150mm Nailon, 11 nails or 4 screws per 40mm length

3.0mm x 130mm Nailon, 10 nails or 3 screws per 40mm length

3.0mm x 240mm Nailon, 19 nails or 5 screws per 40mm length

1.0mm and 2.0mm galvanised Nailon - use Type 17-14g Hex Head Screws

3.0mm galvansied and 1.0mm stainless steel Nailon - use Type 17-12g Hex Head Screws

Stainless Steel Nails and Screws are also available.

As many Nailon products are not stock items, a lead time is sometimes required when ordering. Flat Nailon Plate can be cut to any length, in multiples of 40mm. All folded and special Nailon products are made to order. Order your Nailon requirements through your local LUMBERLOK merchant. Orders directed to us will be charged via your local

- Order to Specify

 1. LUMBERLOK Nailon Plate thickness, width and length in 40mm increments (min. 80mm, max. 2.4m length)
- 2. Special requirements, preferably accompanied by a sketch
- 3. Quantity
- 4. Nail and screw quantity required

Note: Made to order items are non-returnable.

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Project No. 24012 Date

28 AUG 24

Drawn By #Contact ID

Checked By

Drawing Title Mitek fixings Drawing issue

Building Consent

Drawing Scale: 1:1.5913.


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A508 ev Date 4/11/2024 . BC RF 14/10/2024... BC RFI 10/10/2024... BC RFI 17/09/2024... BC RFI

Drawing Number



Note: All window and door opening dimensions to structural framing.

14/10/2024... BC RFI

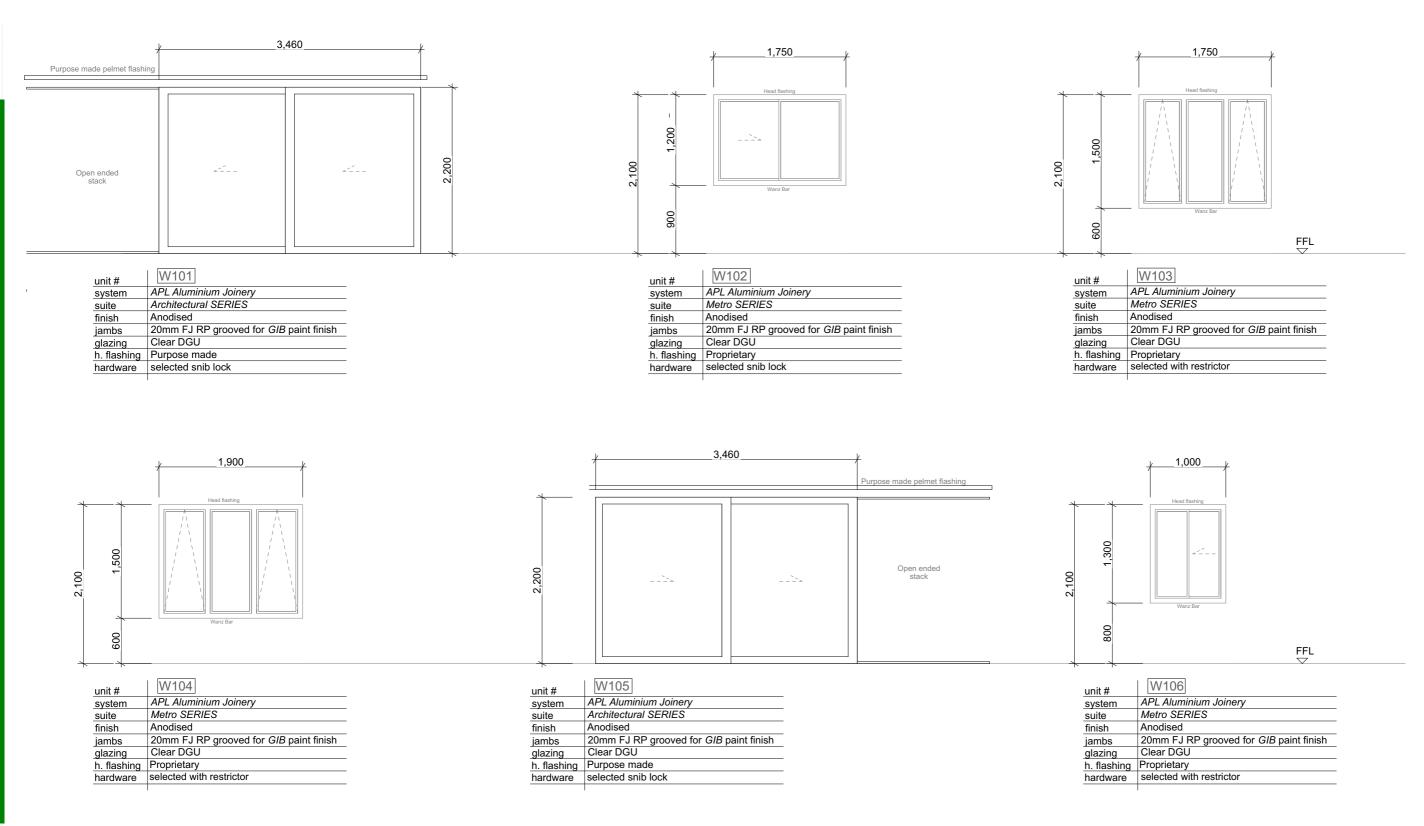10/10/2024... BC RFI 17/09/2024... BC RFI

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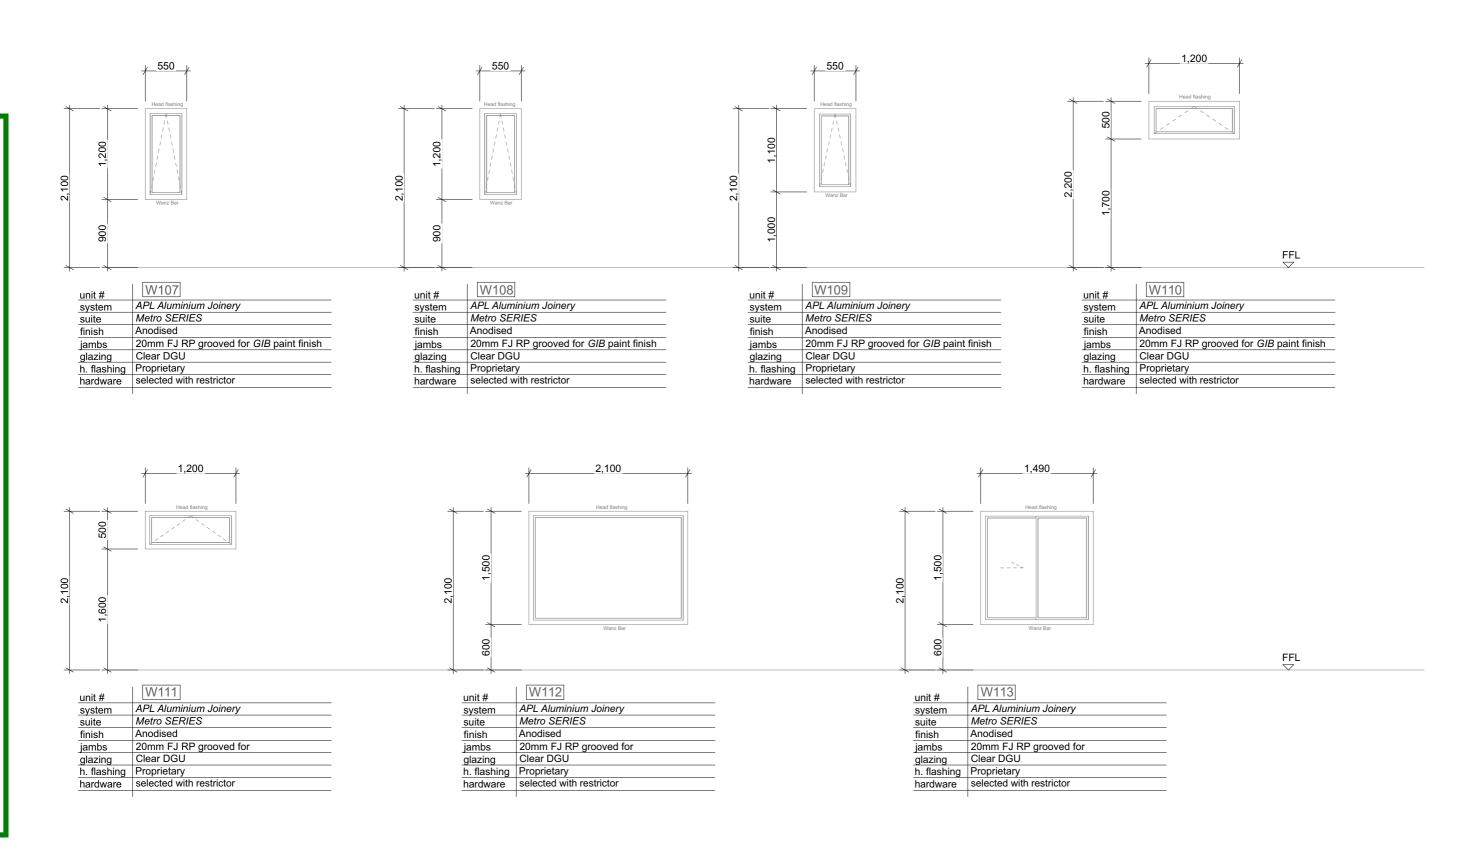
Drawn By #Contact ID Checked By

Drawing Title Window / Door Schedule Drawing issue **Building Consent**

Drawing Scale:

@A3

Drawing Number A601 Rev Date 1:1, 1:50 4/11/2024 ... BC RFI



Note: All window and door opening dimensions to structural framing.

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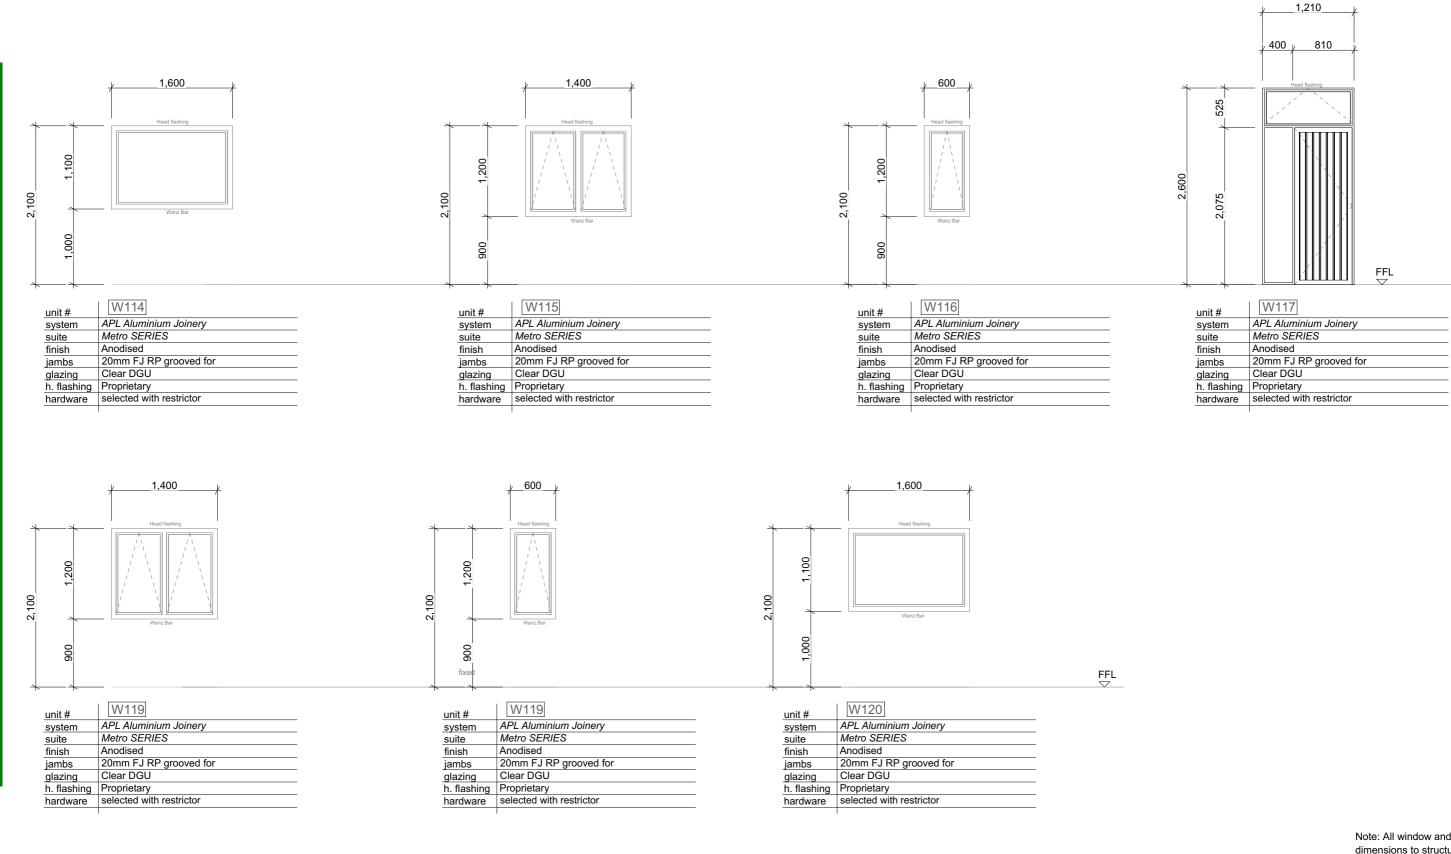
Drawing Title Window/ Door Schedule Drawing issue Checked By **Building Consent**

Drawing Scale: 1:50

@A3

Drawing Number A602

,	7002						
Rev	Date	Title					
D	4/11/2024	BC RFI					
С	14/10/2024	BC RFI					
В	10/10/2024	BC RFI					
Α	17/09/2024	BC REI					



Note: All window and door opening dimensions to structural framing.

Eady Family Additions & Alterations at Oruruhoa Bay, Rawhiti Northland 0184

- 6/11/2024

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Project No. 24012 Date

28 AUG 24

Drawn By #Contact ID

Checked By

Drawing Title Window/ Door Schedule Drawing issue **Building Consent**

Drawing Scale: 1:50

@A3

Drawing Number A603

•	A003						
Rev	Date	Title					
D	4/11/2024	BC RFI					
С	14/10/2024	BC RFI					
В	10/10/2024	BC RFI					
Α	17/09/2024	BC RFI					