

Application for Temporary or Marginal Activity

Pursuant to Section 87BB of the Resource Management Act 1991 (the Act)

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To qualify to be a marginal or temporary activity, a proposed activity must meet the following criteria:

- The activity would be a permitted activity except for a marginal or temporary non-compliance with requirements, conditions, and permissions specified in this Act, regulations (including any national environmental standard), a plan, or a proposed plan; and
- Any adverse environmental effects of the activity are no different in character, intensity, or scale than they would be in the absence of the marginal or temporary non-compliance referred to above; and
- Any adverse effects of the activity on a person are less than minor.

Prior to, and during, completion of this application form, please refer to Resource Consent Guidance Notes and Schedule of Fees and Charges – both available on the Council's web page.

1. Pre-Lodgement Meeting						
Have you met with a Council Resource Consent representative to discuss this application prior to lodgement?						
2. Applicant Details	5:					
Name	Olaf Guy Eady and Simon Holm Eady and Joanna Maitland Chaplin					
Email (Electronic address for service)						
Postal address (or alternative method of service under section 352 of the Act)						
, , , , , , , , , , , , , , , , , , , ,	Postcode					
3. Address for Corre	espondence:					
Name and address for service an	d correspondence (if using an Agent write their details here).					
Name	Graeme Cunningham					
Email (Electronic address for service)						
Postal address						
(or alternative method of service under section 352 of the Act)						
	Postcode 1025					

All correspondence will be sent by email in the first instance.

Please advise us if you would prefer an alternative means of communication.

4. Details of Property Owner/s and Occupier/s:				
(Name and Address of the Owner/Occupiers of the land to which this application relates (where there are multiple owners or occupiers please list on a separate sheet if required)				
Name / s	As per applicant			
Property address / location				
	Postcode			
5. Application Site D	Details:			
Location and/or Property St	reet Address of the proposed activity:			
Site address/location]			
Legal description	Ī			
Certificate of title				
_				
	ttach a copy of your Certificate of Title to the application, along with relevant consent notices r easements and encumbrances (search copy must be less than 6 months old)			
6. Description of the	e Temporary or Marginal Activity:			
	oposal in sufficient detail to justify whether the activity is a 'marginal' or temporary' activity. and assessment of any District Plan rules which the proposed activity does not comply with:			
Rule: 12.4.6.1.2 FIRE RISK TO RESIDENTIAL UNITS The existing house was consented with landscape trees in very close proximity. The proposed extension is minor, being only 300mm past the existing building line and therefore any change in the relationship of the building to any surrounding trees is less than minor. The activity would be permitted activity except for marginal				
	onmental effects of the activity are no different in character, intensity, or scale than they would be in the absence of the marginal			
& infinite volume of seawater from the beach which are mitigating factors. The activity can be considered marginal and not in conflict with the current district plan Rule: 10.6.5.1.2 RESIDENTIAL INTENSITY				
A second laundry and kitchenette is proposed to the existing dwelling. This is an overflow space for holiday guests and or the kids and their friends. The owners will not be using the space as a second tenancy as suggested. Evidence of this is no tenancy fire/acoustic separation upgrades are proposed via				
BC to create a second legal sleeping cell. The activity would be a permitted activity except for a marginal or temporary non-compliance with requirements,				
there are no adverse environmental effects and no adverse effects of the activity. Therefore the activity can be considered marginal and not in conflict with the current district plan.				
7. Other Consent required/being applied for under different legislation:				
(more than one circle can be ticked)				
Building Consent (BC re	f # if known) BC EBC-2025-168/0			
Other (please specify)				

9. Billing Details	5:						
This identifies the person or entity that will be responsible for paying any invoices or receiving any refunds associated with processing this resource consent. Please also refer to Council's Fees and Charges Schedule.							
Name / s	Guy Eady						
Postal address (or alternative method of service under section 352 of the Act)							
Work phone							
Email (Electronic address for service))						
application in order for reasonable costs of wo amounts are payable be payments if your application concerning lower understand that the	Fees Information An instalment fee for processing this application is payable at the time of lodgement and must accompany your application in order for it to be lodged. Please note that if the instalment fee is insufficient to cover the actual and reasonable costs of work undertaken to process the application you will be required to pay any additional costs. Invoiced amounts are payable by the 20th of the month following invoice date. You may also be required to make additional payments if your application requires notification. Declaration concerning Payment of Fees						
pay all and future proc if any steps (including t to pay all costs of recov society (incorporated of	application. Subject to my/our rights under Sections 357B and 358 of the RMA, to object to any costs, I/we undertake to pay all and future processing costs incurred by the Council. Without limiting the Far North District Council's legal rights if any steps (including the use of debt collection agencies) are necessary to recover unpaid processing costs I/we agree to pay all costs of recovering those processing costs. If this application is made on behalf of a trust (private or family), a society (incorporated or unincorporated) or a company in signing this application I/we are binding the trust, society or company to pay all the above costs and guaranteeing to pay all the above costs in my/our personal capacity. Name of bill payer (please print) Signature of bill payer						
	Guy Eady						
Checklist							
Payment							
O Payment (cheque	Payment (cheques payable to Far North District Council)						
A current Certificate of Title (Search Copy not more than 6 months old)							
Copies of any listed encumbrances, easements and/or consent notices relevant to the application							
Applicant / Agent / Property Owner / Bill Payer details provided							
Location of property and description of proposal							
Written approvals and a signed plan from each owner of an allotment with an infringed boundary							
Copies of other relevant consents associated with this application							
Location and Site plans							
Elevations / Floor	plans						
Topographical / co	Topographical / contour plans						
Note to applicant You must include all in	nformation required by this form. If all information	on is not included, the	consent authority will return				

this to you and the correct information must be supplied before a written notice permitting your activity can be provided.

A0	Site	
	A001	Cover Page
	A002	Proposed Site Plan
A1	Plans	
	A101	Existing Ground Floor Plan
	A102	Existing First Floor Plan
	A103	Proposed Ground Floor Plan
	A104	Proposed First Floor Plan
	A105	First Floor Framing and Bracing Plan
	A106	Foundation Plan
	A107	Framing Plans
	A108	Roof Plans
9 2	levations	
1	A201	Elevation
24	A202	Elevation
∆ 3	ections	
2	A301	Section A
ĮĮ,	A302	Section CC
4	roject Specific De	
<u>,</u>	A401	Sliding door Jamb details
Ġ	A402	Sliding door Head & Sill details
of	A403	Details
-	A404	Window Details
Ō	A405	Window Details
<u> </u>	A406	Blockwall cladding details
A5	tandard Details	
8	A501	Foundation Details
16	A502	LUMBERLOK Joist Stiffener & Top Plate Fixing
2	A503	LUMBERLOK Lintel Fixing Schedule
22	A504	LUMBERLOK Purlin & Batten Fixing Detail
men≰ - EBC-2025-168/0 _万 Pg 1 of 31 - ≨/11/2624	A505	Roof Bracing & Durability for Steel Fixing/Fastenings
<u>Ų</u>	A506	Framing Fixing Detail
# I	A507	Wet Area Detail
ī.,	A508	Mitek fixings
≱ 6	Vindow/Door Sche	dule
ᅙ	A601	Window / Door Schedule
Ę	A602	Window/ Door Schedule
ರ	A603	Window/ Door Schedule
SIT	INFORMATION	
→ A[DRESS: 178 RAWHIT	TI ROAD, RAWHITI 0184
ш	SAL DESCRIPTION: I	Lot 2 DP 122586
	E AREA: 5623m² RTHQUAKE ZONE : Z	ONE 1
Ģ E>	OSURE ZONE: ZON	
Ow	ID ZONE: HIGH	
AR	HITECTURAL A	RRPEVIATIONS
7		
CI CI		on & architectural break
	-	
O FF	finished floor le	evel
© F⊄	H front of house	ng dimension
6 (H		ng almension benching for electrical
2 0/		•
2 0F		nsions - clear from timber framing
ST TE		ning dimension d by contractor with BF
O		•
ונ <mark>ק</mark>		t in conjunction with all concultants drawings
£'	Notify architect of a	d in conjunction with all consultants drawings. any discrepancies.
	NEW WORK: Timb	or framing to comply with N7C2C04 MCC9 or co

the fall height exceeds 1.0m AND where the upstairs WC or any other fixed features are located within 500mm horizontal of an opening window.

ARCHITECTURAL LEGEND

EXISTING

exta, timber framed walls

extg. timber framed walls removed

extg. timber framed walls upgraded

extg. 250mm concrete block wall extg. 200mm concrete block wall

WALL 1

90x45mm timber framed wall w. studs at 400mm crs nog vertically @ 800mm crs EXTERIOR: install PINK BATTS CLASSIC

R2.2 insulating wall pads to all external walls. Selected cladding to exterior also refer to elevations for cladding. INTERIOR: 10mm gib for stopped & L4 paint finish interior.

BATHROOM: 10mm GIB AQUALINE

PROPOSED JOINERY

ALUMINIUM JOINERY

new SELECTED aluminium window DGU all clear glass.

Obscure glass for bathrooms. Refer to window schedule

INTERIOR: DOOR JOINERY

new 40mm hollow core panel door for paint finish w. selected hardware. Groved iamb for gib. Color TBC

GENERAL

terminal vent

٧

HPM INLINE ceiling Exhaust fan for min 50L/s exhaust 100mm duct. Refer to elevations for location

check on site

oa

ELECTRICAL

of gravity grille.



Domestic Smoke Alarm*

*Smoke alarms complying with one of the standards:UL217, ULC S531, AS3786, BS5446:Part1, are to be installed on or near the ceiling in accordance with Australian Standard AS1670.6. Alarms must have a hush facility located on the alarm itself. Owner is responsible for maintenance of the system as per manufacturer's recommendation



hotwater cylinder

Install 100mm proprietary restrictors for all window sill openings within 760mm from the inside floor level where

ELEMENTAL LEGEND

All fixings in accordance with NZS3604.2011unless noted otherwise

STRUCTURE: all new timber structure SG8

- S 20) new timber lintel-w/ min. uplift-fixing as per A4.05 LUMBERLOC fixing schedule
- (\$ 21) new timber stringer 140x45 H3.2 fixed with M12 bolt @1200crs
- (\$ 30) new 90x45 wall studs @ 400 ctrs nog @ 800mm crs, top & bottom plates, fixed as per NZS 3604
- S 31) selected flooring material CHH ECOPLY 18mm flooring
- (\$ 32) new rafters framing at 900 crs subject to site measure install
- (\$33) new 70x45mm timber purlin T fixing 1/10gm self drilling screw 80mm long (alternative 2.4kN fixing permitted)
- S 34) LUMBERLOK 0.55x27mm G550 Z275 roof strip brace
- (S 40) selected 18mm timber decking fixed with SPAX screws TBC
- (S 41) timber deck joist or deck batten
- (S 42) balustrade TBC
- S 50 125x125mm H5 senton pile ordinary & braced 600mm deep minimum anchor 900mm deep minimum

- (E 01) THERMAKRAFT dpc
- © SIKA BLACK SEAL ELASTIC brush applied waterproofing coating
- E 03) THERMAKRAFT supercourse 500
- **E 10** Roof THERMAKRAFT COVERTEK 407 to lap
- E 11) Walls THERMAKRAFT WATER GATE PLUS to lap
- E 12 THERMAKRAFT ALUBAND flashing tape
- (E 13) 10mm H3.2 treated timber packer and airseal.
- (E 14) nylon packer
- (E 15) 6mm JH VILLABOARD LINING soffit plastered smooth
- E 16) 20x20mm timber scriber w/ silicone seal
- E 17) 90x10mm single bevel skirting boards
- (E 18) 60x10mm to match extg architrave
- (E 19) battens H3.2 90x20mm over exterior grade jack framing 20mm gap
- E 20 H3.2 to match extg RP bevelback weatherboard circa 135x18mmm for paint finish direct fix with galvanised 60x2.8mm nails. Refer paint finishes schedule &color schedule.
- E 24) HUME PINE PINECLAD H3.1 Square Dressed Board 90x18mm
- E 25) HUME PINE PINECLAD H3.1 Square Dressed Board 180x18mm DS4 cut suit
- E 26 HUME PINE PRO SCRIBER 18mm H3.1 w/ silicone seal (E 27) HUME PINE PINECLAD H3.1 timber fascia. Color to match - TBC
- (E 28) REDWAYEXTRUSIONS uPVC 20mm cavity closer
- (E 29) REDWAYEXTRUSIONS uPVC flashing. Refer product for selection.
- $\hbox{$\stackrel{\frown}{\hbox{E}$ 30}$} \ \ ROOFING\ INDUSTRIES\ CORRUGATE\ \ profile\ 0.55mm\ \ BMT\ COLORSTEEL.$
- 0.4mm BMT COLOUR STEEL flashing to match purpose made. Match roofing
- (E 32) QUICKFLASH aluminium flashing. Refer QUICKFLASH product code for selection
- © 33 ROOFING INDUSTRIES QUARTER ROUND GUTTER with COLOURSTEEL dp. Match roofing refer Colour Schedule. (E 34) VIKING TPO ENVIROCLAD membrane over 17.5 mm plywood SS screw fixing
- (E 35) DEKTITE PREMIUM flashing boot installed according to manufactures instructions - allow for the correct size
- (E40) APL ALUMINIUM JOINERY w. DGU Awning, sliding and fixed windows, double track & entrance doors refer drawings. Confirm and allow for floor finishes including depth of carpet when constructing set down. Refer to colour schedule
- (E 42) timber window joinery

substrate on timber framing

- (E 50) PROPRIETARY window head flashing by window supplier
- E 51) RASOGUM+ liquid-applied waterproofing membrane
- E 52 Bowmac SS175 each side bracket connection bearer to conc block wall
- E 53) SS joist hang joists to stringer

for 90mm timber framing

- (i 01) R2.2 KNAUF wall insulation 90mm thk.
- (i 02) R3.6 KNAUF ceiling insulation 175mm thk. insulation post install.
- R1.5 KNAUF floor insulation 70mm thk.
- (i 04) 10mm thk polystyrene insulation strip (0.25m2 C/W)

FINISHES LEGEND WALL FINISHES TYPICAL NEW WALL new 10mm G/B board stopped level 4 paint finish direct fix to timber framing square stop at ceiling. Allow where required for packing to match existing gauge. Skirting LAUNDRYWALL & BATHROOM New 12mm T&G&V wall lining direct fix or on GIB selected client supplied tile over substrate CL1 NEW TYPICAL SOFFIT new JH VILLABOARD SOFFIT LINING stopped & level 4 paint finish CL2 NEW TYPICAL CEILING new 13mm GIB STANDARD or alternative stopped & level 4 paint finish on ceiling battens 65x35mm @ 600mm crs. FLOOR FINISHES new T&G solid wood flooring to match existing over polyurethane substrate FL2 Selected floor tile on 6mm james hardie backer board DL1 DECK 140mm timber decking w. SS fixings

DRAINAGE & PLUMBING LEGEND description SS drain pipe. Refer plan for size. SW drain pipe subfloor riser. Refer to plan for size. 50 mm sleeve for 100DN 80DN down pipe minimum for SW. Refer plan for downpipe 65DN minimum termnial vent to roof for branch drain. Boot flashing over roof penetration arrow slope down - indicates all fall to main drain connection Overflow relief gully. Sill cock to charge OFG. Inspection point laundry washing tub air admittance valve Tile Shower man hole Т Town water supply connection all pipes minimum grade falls in wall: 40DN 1:40 AS PER G13 OR AS/NZS 3500 all pipe support points to be: 50mm 500mm AS PER G13 OR AS/NZS 3500 Plumbing Contractor is to verify that all plumbing fixture level and pipe gradients meet minimum building code and plumbing standards before starting work. Hot water cylinder shall have operating devices, safety devices, a drainer safe tray and seismic restraints in accordance with NZBC Hot water pipework shall be thermally insulated

GOODHOUSE

IIIVIBEK IKEATI	MENT & GRADE S	PECIFICA	IIUN
Member	Species	Grade	Treatment
FLOOR FRAMING - F	RADIATA PINE		
Mid floor joists:	Radiata pine	SG8	H1.2
Boundary joists:	Radiata pine	SG8	H1.2
EXTERIOR WALL FR	AMING - RADIATA PI	NE	
Exterior walls:	Radiata pine	SG8	H1.2
Parapets: Enclosed decks and balc	Radiata pine	SG8	H1.2
	Radiata pine	SG8	H1.2
Cantilevered joists enclos	sed decks and balconies: Radiata pine	SG8	H3.2
Wall battens (not cavity):		Manala	111.2
Jamb battens:	Radiata pine Radiata Pine	Merch Merch	H1.2 H3.1
CAVITY BATTENS			
OAVIII BAITENO			
Cavity battens Species G Non Structural:	rade Treatment Timber - Radiata pine	Merch	H3.1
	'	11101011	113.1
ROOF FRAMING - RA	ADIATA PINE		
Rafters:	Radiata pine	SG8	H1.2
Trusses: Purlins:	Radiata pine Radiata pine	SG8 SG8	H1.2 H1.2
Ceiling joist & batten:	Radiata pine Radiata pine	SG8	H1.2 H1.2
Valley boards:	Radiata pine	Merch	H1.2
Valley boards: Sarking:	Radiata pine Radiata pine	Merch	H1.2
Skillion roof framing:	Radiata pine Radiata pine	SG8	H1.2 H1.2
Enclosed flat roof framing		SG8	H1.2
INTERIOR FRAMING	- RADIATA PINE		
Non structural walls:	Radiata pine	SG8	H1.2
Structural and braced wa		SG8	H1.2
EXTERIOR EXPOSE	D TIMBERS		
Posts:	Radiata pine	SG8	H3.2 CCA
Joists:	Radiata pine	SG8	H3.2 CCA
Exterior stairs and steps:	Radiata pine	SG8	H3.2 CCA
Pergola:	Radiata pine	SG8	H3.2 CCA
Ground contact member	s Radiata pine	SG8	H5 CCA

Additions & Alterations for Eady Family at Oruruhoa Bay, Rawhiti Northland 0184

DIMENSIONS: Manufacturer to check dimensions, levels and trueness of walls on site. Where joinery unit is made to fit between walls or full height to underside of ceiling, generally allow for maximum 5mm clearance between joinery unit & wall/ceiling lining to ensure trouble free installation on site. Fill gap with approved black compressible strip to form negative detail.

NEW WORK: Timber framing to comply with NZS3604 - MSG8 or as

NEW WORK: Timber treatment to comply with NZS3602 - refer to

otherwise noted on drawings.

COMPONENT EXTERIOR WALLS

INTERIOR WALLS JOIST/RAFTERS - ENCLOSED

specification section 3801 carpentry.



Location Plan


NTS



Site Image

Building Coverage N	et	m2	
House (extg)		301.7	
Addition		2.1	
Total	5.40 %	303.8	COMPLIES
Impermeable Cover	rage Gross	m2_	
Building Coverage		303.8	
Driveway		663.4	
Conc driveway area	to be removed	- 2.1	NO CHANGE
Total	17.16 %	965.1	
Landscape area		m2	
Landscape		4631.7	
Total	82.37 %	4631.7	COMPLIES

	LEGEND
	New Extension
	Existing building
	New deck
$T_{s_{s_{s_{s_{s_{s_{s_{s_{s_{s_{s_{s_{s_$	Existing driveway

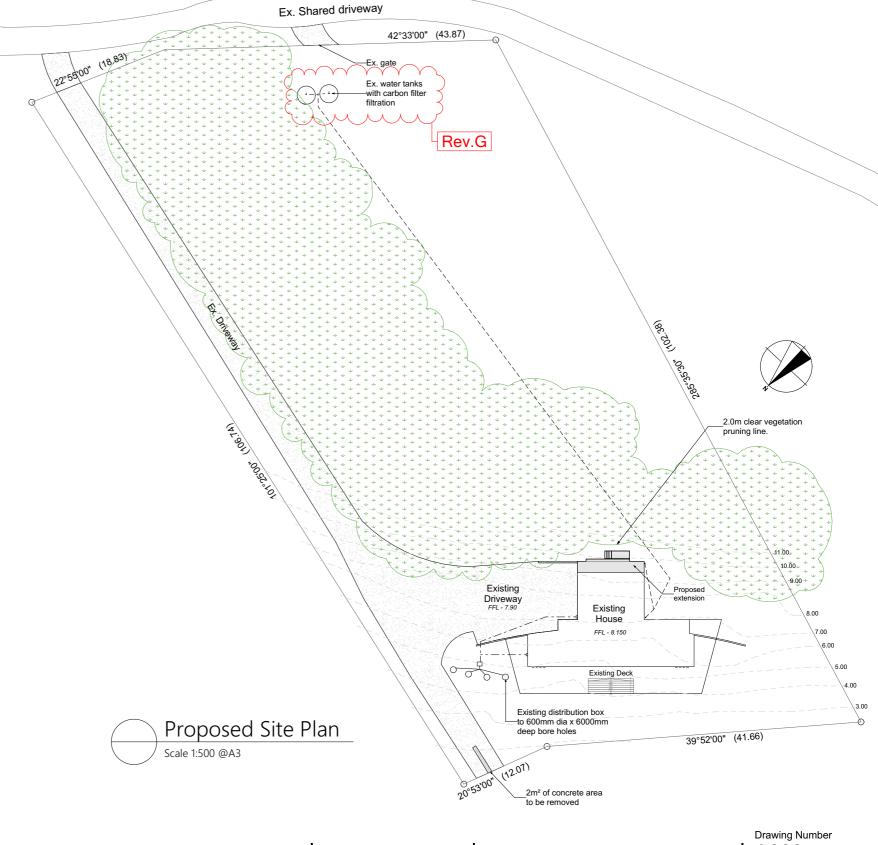

Client
Eady Family
Project
Additions & Alterations
at Oruruhoa Bay, Rawhiti Northland 0184

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Rawhiti Road

Project No. 24012

Date

28 AUG 24

Drawn By #Contact ID

Checked By

Drawing Title
Proposed Site Plan
Drawing issue

Building Consent

Drawing Scale:


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A002G

Rev Date Title
G 05/12/25 3... Revision
F 05/11/25 1... HOLD ON WORKS
E 13/11/24 4:... BC

05/11/24 1... BC RFI 14/10/24 1... BC RFI



Client
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Additions & Alterations
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Project No. 24012 Date

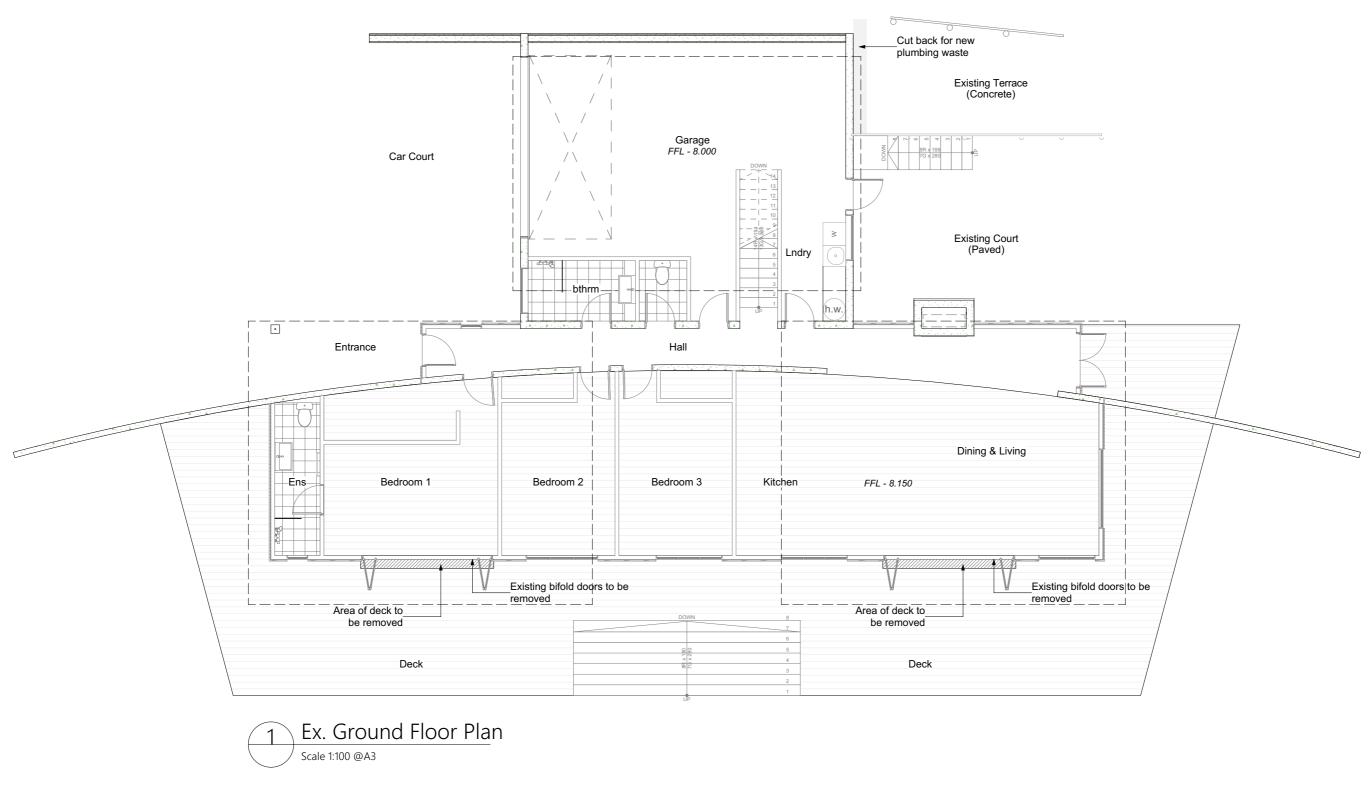28 AUG 24

Drawn By #Contact ID Checked By Drawing Title
Existing Ground Floor Plan
Drawing issue
Building Consent


Drawing Scale:

1:100

@A3

Drawing Number
A 1 0 1

Rev Date Title
D 4/11/2024... BC RFI
C 14/10/2024... BC RFI

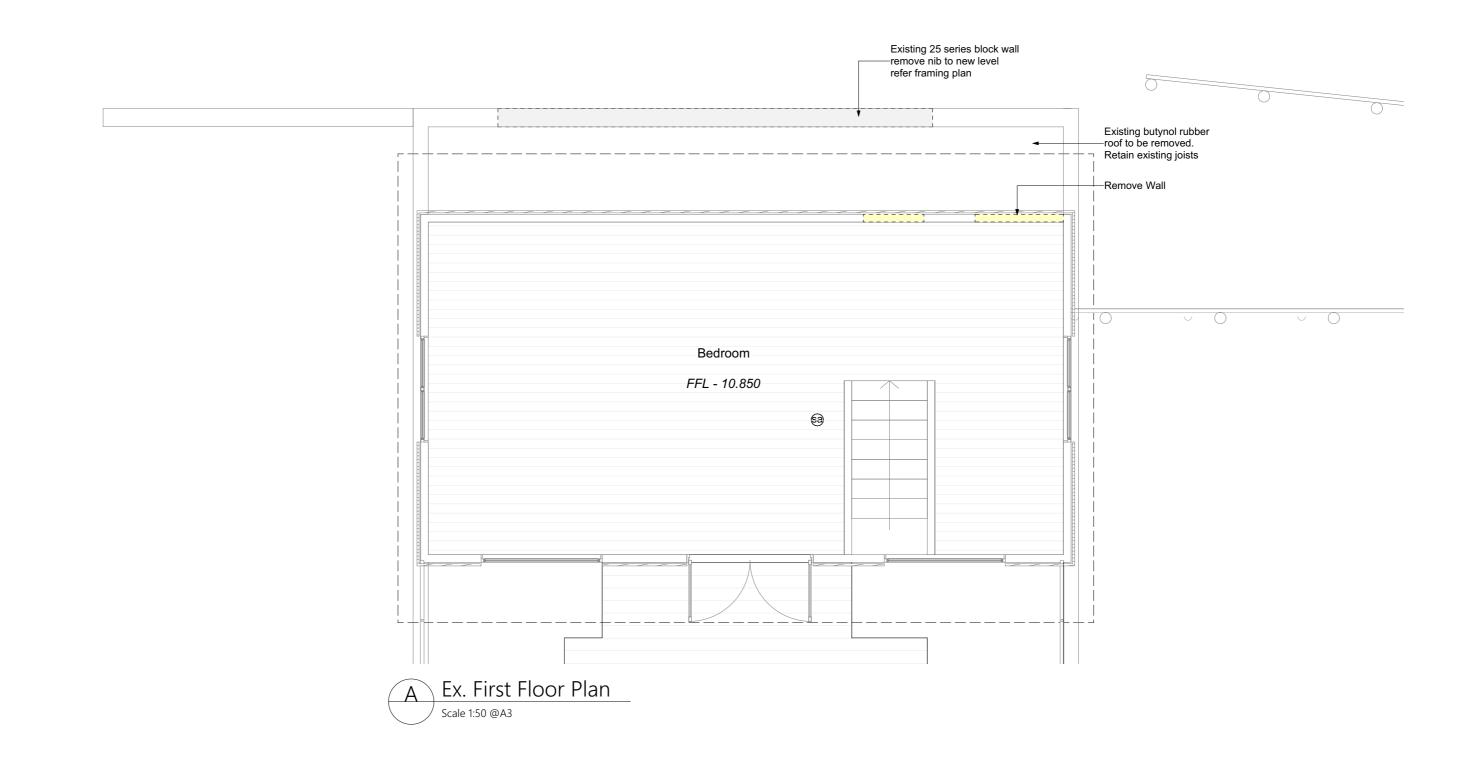

Eady Family Additions & Alterations at Oruruhoa Bay, Rawhiti Northland 0184

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Project No. 24012 Date

28 AUG 24


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Drawing Title Existing First Floor Plan Drawing issue

Building Consent

Drawing Scale:

Drawing Number A102 Rev Date 1:50 4/11/2024 ... BC RFI @A3

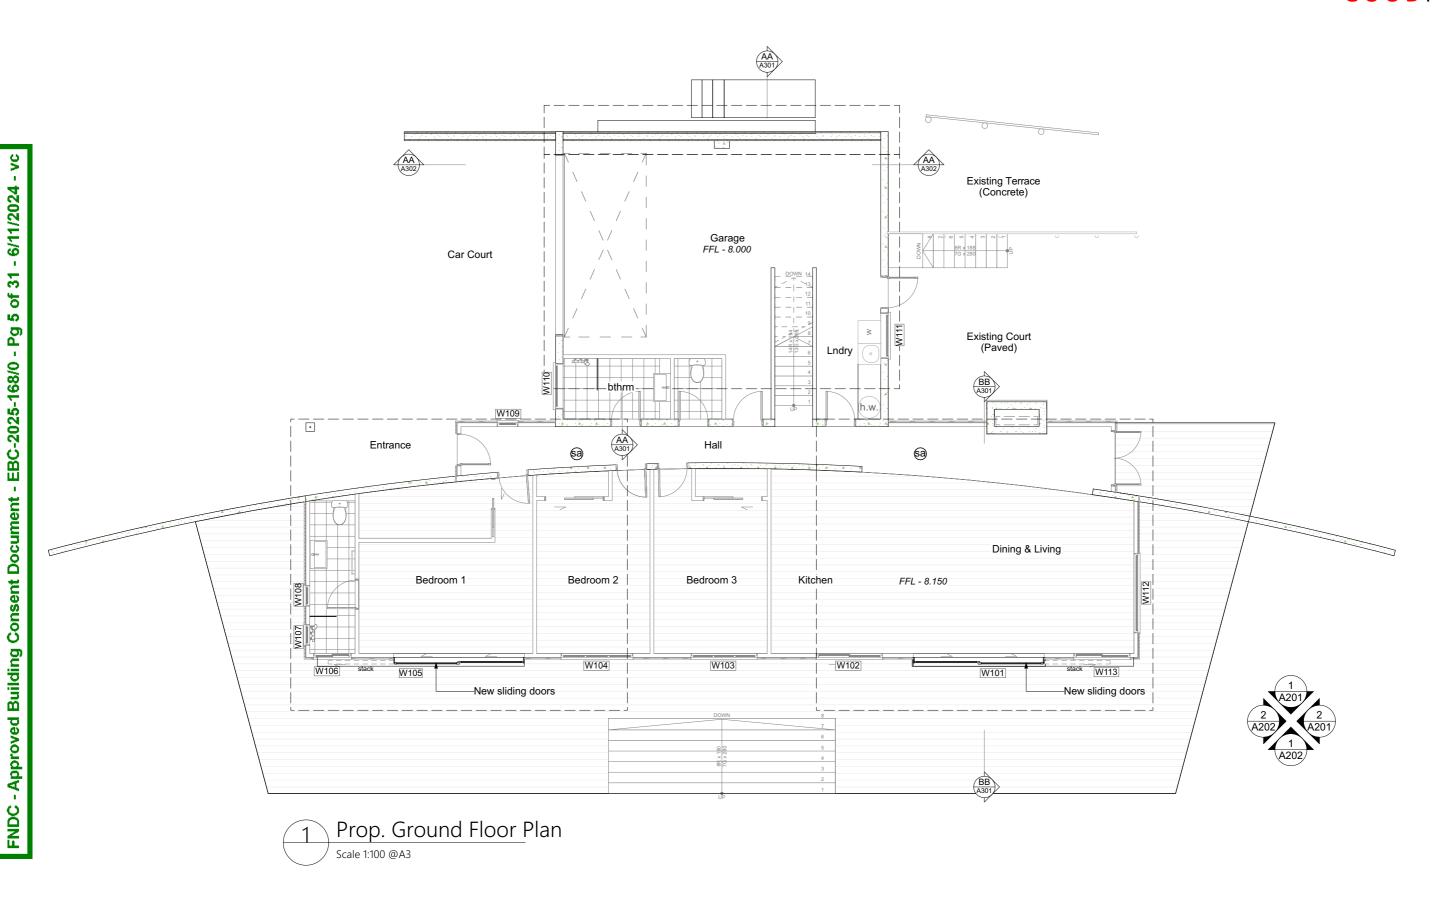

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Project No. 24012 Date

28 AUG 24

Drawn By #Contact ID

Checked By

Drawing Title Proposed Ground Floor Plan Drawing issue

Building Consent

Drawing Scale:


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A103 ev Date 4/11/2024 ... BC RFI

Drawing Number

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Building Consent


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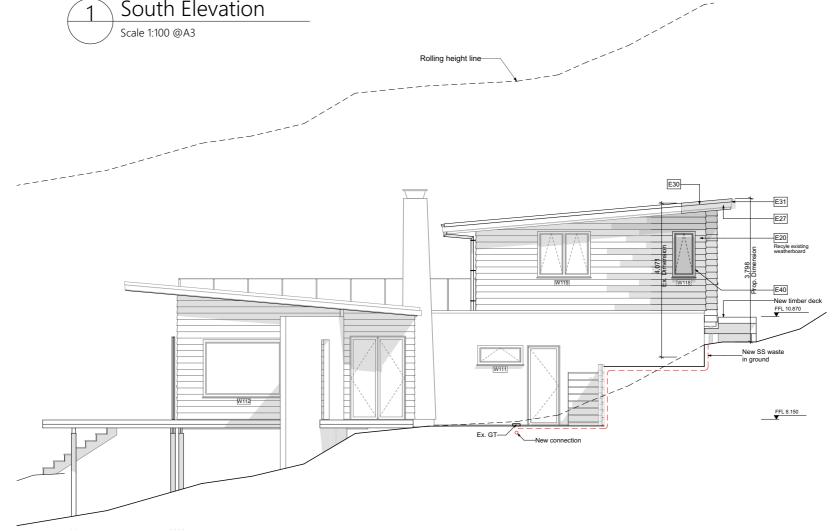
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@A3

Drawing Number I A104_G
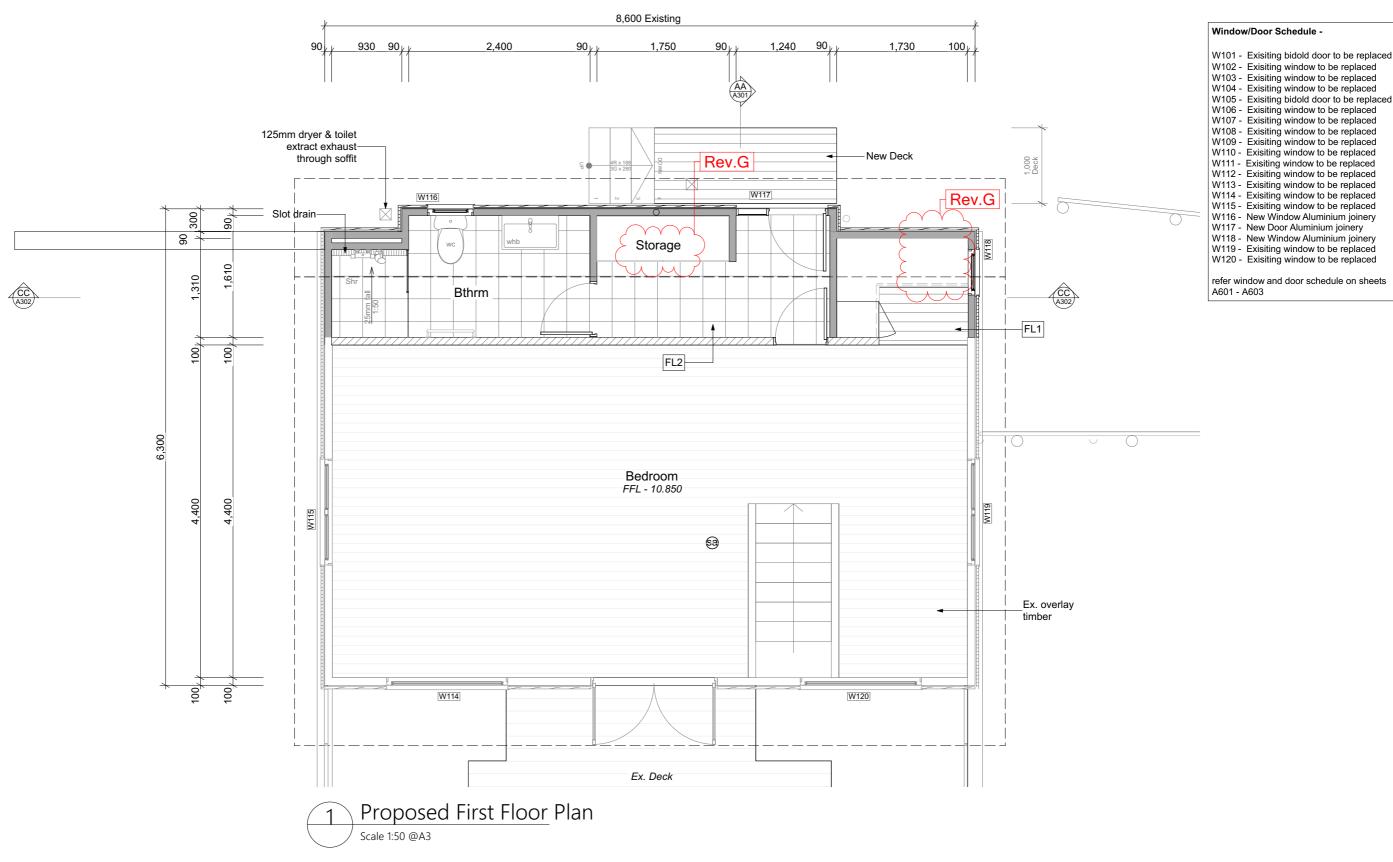
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Rev	Date	Title
G	05/12/25 3	Revision
F	05/11/25 1	HOLD ON WORKS
Е	13/11/24 4:	BC
D	05/11/24 1	BC RFI
С	14/10/24 1	BC RFI



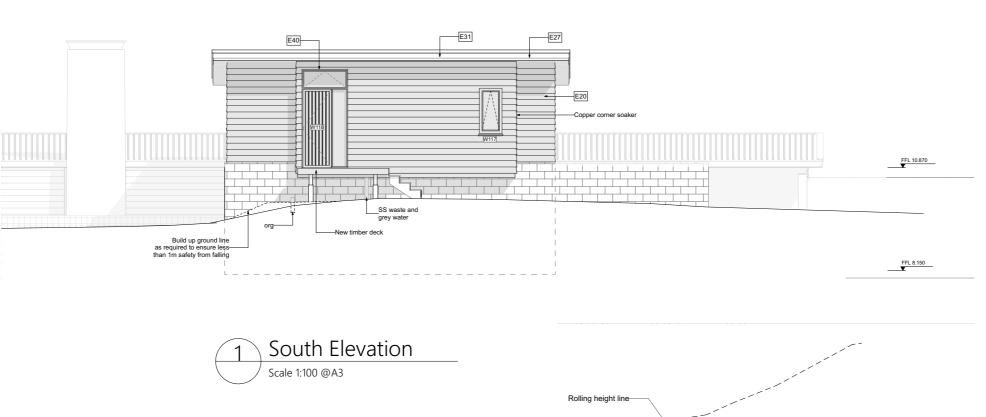

West Elevation
Scale 1:100 @A3

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Project No. Drawn By 24012 #Contact ID

Date Checked By

Date Checked By 28 AUG 24

Drawing Title
Elevation

Drawing issue
Building Consent

Drawir Scale: 1:100

Risk Factor

Eaves width

Deck design
Total Risk Score:

Risk Factor

Eaves width

Deck design

Wind zone (per NZS 3604)

Wind zone (per NZS 3604)

Roof/wall intersection design

@A3

Number of storeys

Envelope complexity

Roof/wall intersection design

Number of storeys

Envelope complexity

BUILDING ENVELOPE RISK MATRIX
South Elevation

BUILDING ENVELOPE RISK MATRIX
West Elevation

Rev Date Title
D 4/11/2024 ... BC RFI
C 14/10/2024 ... BC RFI
B 10/10/2024 ... BC RFI
A 17/09/2024 ... BC RFI

Risk Severity Risk Score

Risk Severity Risk Score

0

0

High risk

Low risk

Medium risk

Low

High risk


High risk

Low risk

Medium risk

Low

High risk

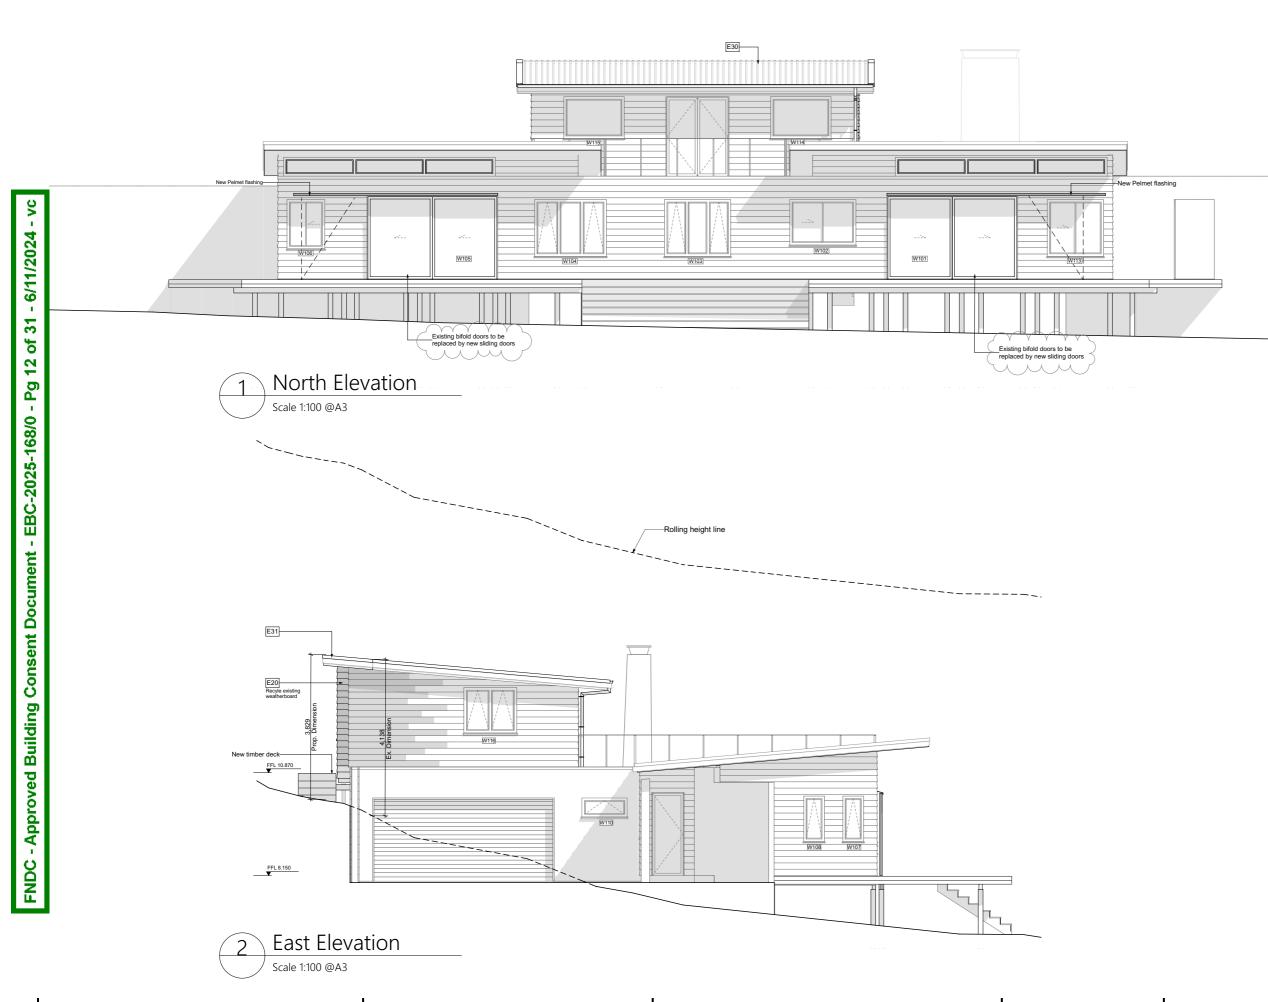

North Elevation				
Risk Factor	Risk Severity	Risk Score		
Wind zone (per NZS 3604)	High risk	1		
Number of storeys	High risk	2		
Roof/wall intersection design	Low risk	0		
Eaves width	Medium risk	1		
Envelope complexity	Low	0		
Deck design	High risk	4		
Total Risk Score:		8		

BUILDING ENVELOPE RISK MATRIX

BUILDING ENVELOPE RISK MATRIX					
West Elev	/ation				
Risk Factor	Risk Severity	Risk Score			
Wind zone (per NZS 3604)	High risk	1			
Number of storeys	High risk	2			
Roof/wall intersection design	Low risk	0			
Eaves width	Medium risk	1			
Envelope complexity	Low	0			
Deck design	High risk	4			
Total Risk Score:		8			
	Drawing Num	iber			

Eady Family Additions & Alterations at Oruruhoa Bay, Rawhiti Northland 0184

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Project No. Drawn By #Contact ID 24012 Date

Checked By 28 AUG 24

Drawing Title Elevation Drawing issue **Building Consent** Drawing Scale:

1:100

@A3

A202c Title Rev Date